

~DEPART FROM VERIZON WIRELESS OFFICE AT: 10300 OLD ALABAMA ROAD, ALPHARETTA, GA 30022 ~GET ON GA-400 N/US-19 N FROM MANSELL RD AND HAYNES BRIDGE RD ~MERGE ONTO GA-400 N/US-19 N ~TAKE EXIT 17 FOR GA-306 TOWARD GAINESVILLE ~USE THE RIGHT 2 LANES TO TURN RIGHT ONTO GA-306 E ~TURN RIGHT ONTO HWY 53 E ~TURN LEFT ONTO SARDIS RD ~TURN LEFT TO STAY ON SARDIS RD ~AT THE TRAFFIC CIRCLE, TAKE THE 1ST EXIT ONTO LEDAN RD/LEDAN EXT ~TURN LEFT ONTO GA-60 N ~TURN RIGHT ONTO GA-283 N ~TURN RIGHT ONTO JIM HOOD RD ~TURN LEFT ONTO ODUM SMALLWOOD RD, KEEP LEFT AT THE FORK SITE IS ON THE RIGHT IN .09 MILES

DEPARTMENT	NAME/SIGNATURE	DATE
LAND/TOWER OWNER		
SITE ACQU. AGENT		
ZONING/PERMITTING AGENT		
A&E MANAGER		
CONSTRUCTION MANAGER		
RF MANAGER		

PREPARED FOR:



PROJECT DESCRIPTION: RAW LAND NSB

SITE NAME:

HALLWAY

VERIZON LOCATION CODE:

318965



Know what's below Call before you dig

* * * C A U T I O N * * *

THE UTILITIES SHOWN HEREON ARE FOR THE CONTRACTOR'S CONVENIENCE ONLY. THERE MAY BE OTHER UTILITIES NOT SHOWN ON THESE PLANS. THE ENDIREE ASSUMES NO RESPONSIBILITY FOR THE LOCATIONS SHOWN AND IT SHALL BE THE CONTRACTOR'S RESPONSIBILITY TO VERIEY ALL UTILITIES WITHIN THE LIMITS OF THE WORK. ALL DAMAGE MADE TO EXISTING UTILITIES BY THE CONTRACTOR SHALL BE THE SOLE RESPONSIBILITY OF THE CONTRACTOR.

FOR EMERGENCIES CALL: 911

PROJECT INFORMATION

SITE ADDRESS: 5182 ODUM SMALLWOOD RD GAINESVILLE, GA 30506

LATITUDE: 34° 25′ 48.75″ (NAD 83) LONGITUDE: -83° 49′ 52.11″ (NAD 83)

PARCEL ID: 12004 000019

JURISDICTION: HALL COUNTY

ZONING CLASSIFICATION: AR-IV

PROPERTY OWNER: JIMMY LEON CLARK
PROPERTY OWNER PHONE: (678) 617–9556

APPLICANT: VERIZON WIRELESS
10300 OLD ALABAMA ROAD

ALPHARETTA, GA 30022

ENGINEER: FORESITE GROUP, LLC 3740 DAVINCI CT, SUITE 100

PEACHTREE CORNERS, GA 30092

POWER: JACKSON EMC

TELCO: AT&T

DESIGN DATA:

BASIC:

DESIGN CODE:

INTERNATIONAL BUILDING CODE: 2012 EDITION WITH 2014, 2015, 2017 & 2018 GEORGIA

AMENDMENTS & TIA/EIA TIA-222-H

, 115 MPH (PER 2012 IBC)

EXPOSURE CATEGORY: CRISK CATEGORY: II

SHEET INDEX

	J.:==::::\ J	
SHEET	DESCRIPTION	REV.
T-1	TITLE SHEET	0
T-2	CONSTRUCTION NOTES	0
T-3	SITE SIGNAGE	0
V-1	SURVEY	0
V-2	SURVEY	0
C-0	TOWER SETBACK AERIAL	0
C-1	OVERALL SITE PLAN	0
C-1.1	CATTLE GATE DETAIL	0
C-2	ENLARGED SITE PLAN	0
C-3	GRADING & EROSION CONTROL PLAN	0
C-3.1	GRADING & EROSION CONTROL PLAN	0
C-3.2	EROSION CONTROL DETAILS	0
C-3.3	EROSION CONTROL DETAILS	0
C-3.4	EROSION CONTROL DETAILS	0
C-3.5	EROSION CONTROL DETAILS	0
C-3.6	EROSION CONTROL DETAILS	0
C-3.7	EROSION CONTROL DETAILS	0
C-4	EQUIPMENT DETAILS	0
C-5	TOWER ELEVATION & ANTENNA ORIENTATION	0
C-6	FOUNDATION & ACCESS DRIVE DETAILS	0
C-7	ICE BRIDGE DETAILS	0
C-8	FENCE DETAILS	0
C-9	GENERATOR DETAILS	0
E-1	ELECTRICAL NOTES	0
E-2	ONE-LINE DIAGRAM & PANEL SCHEDULE	0
E-3	SITE SERVICE ROUTING & COMPOUND GROUNDING PLAN	0
E-4	SITE SERVICE ROUTING & EQUIPMENT GROUNDING PLAN	0
E-5	GROUNDING DETAILS	0
E-6	GROUNDING DETAILS	0
E-7	GROUNDING DETAILS	0
E-8	UTILITY H-FRAME DETAILS	0





SEAL:



PROJECT:

HALLWAY 318965

LOCATED AT: 5182 ODUM SMALLWOOD RD GAINESVILLE, GA 30506

APPROVALS

CARRIER _____

LANDLORD _____

LEASING _____

CONSTRUCTION _____

REVISIONS DATE

ISSUED FOR: PERMIT/CONSTRUCTION
PROJECT MANAGER: MWM
DRAWING BY: ALK
DATE: 02/07/20
TITLE:

TITLE SHEET

SHEET NUMBER: T-1

JOB/FILE NUMBER: 1010.001

GENERAL NOTES:

1. FOR THE PURPOSE OF THE CONSTRUCTION DRAWINGS, THE FOLLOWING DEFINITIONS SHALL APPLY:

> CONTRACTOR - GENERAL CONTRACTOR (CONSTRUCTION) TOWER OWNER - VERIZON WIRELESS

- PRIOR TO THE SUBMISSION OF BIDS, THE BIDDING CONTRACTOR SHALL VISIT THE CELL SITE TO FAMILIARIZE WITH THE EXISTING CONDITIONS AND TO CONFIRM THAT THE WORK CAN BE ACCOMPLISHED AS SHOWN ON THE CONSTRUCTION DRAWINGS. ANY DISCREPANCY FOUND SHALL BE BROUGHT TO THE ATTENTION OF THE ENGINEER
- 3. ALL MATERIALS FURNISHED AND INSTALLED SHALL BE IN STRICT ACCORDANCE WITH ALL APPLICABLE CODES, REGULATIONS AND ORDINANCES. CONTRACTOR SHALL ISSUE ALL APPROPRIATE NOTICES AND COMPLY WITH ALL LAWS, ORDINANCES, RULES, REGULATIONS, AND LAWFUL ORDERS OF ANY PUBLIC AUTHORITY REGARDING THE PERFORMANCE OF THE WORK.
- ALL WORK CARRIED OUT SHALL COMPLY WITH ALL APPLICABLE MUNICIPAL AND UTILITY COMPANY SPECIFICATIONS AND LOCAL JURISDICTIONAL CODES, ORDINANCES AND APPLICABLE REGULATIONS.
- UNLESS NOTED OTHERWISE, THE WORK SHALL INCLUDE FURNISHING MATERIALS, EQUIPMENT, APPURTENANCES, AND LABOR NECESSARY TO COMPLETE ALL INSTALLATIONS AS INDICATED ON THE DRAWINGS.
- 6. THE CONTRACTOR SHALL INSTALL ALL EQUIPMENT AND MATERIALS IN ACCORDANCE WITH MANUFACTURER'S RECOMMENDATIONS UNLESS SPECIFICALLY STATED OTHERWISE.
- 7. IF THE SPECIFIED EQUIPMENT CANNOT BE INSTALLED AS SHOWN ON THESE DRAWINGS, THE CONTRACTOR SHALL PROPOSE AN ALTERNATIVE INSTALLATION FOR APPROVAL BY
- CONTRACTOR SHALL DETERMINE ACTUAL ROUTING OF CONDUIT, POWER, FIBER, AND GROUNDING CABLES SHOWN ON THE POWER & GROUNDING DRAWINGS.
- 9. THE CONTRACTOR SHALL PROTECT EXISTING IMPROVEMENTS, PAVEMENTS, CURBS, LANDSCAPING AND STRUCTURES. ANY DAMAGED PART SHALL BE REPAIRED AT CONTRACTOR'S EXPENSE TO THE SATISFACTION OF THE OWNER.
- 10. CONTRACTOR SHALL LEGALLY AND PROPERLY DISPOSE OF ALL SCRAP MATERIALS SUCH AS COAXIAL CABLES AND OTHER ITEMS REMOVED FROM THE EXISTING FACILITY.
- 11. CONTRACTOR SHALL LEAVE PREMISES IN CLEAN CONDITION.
- 12. CONTRACTOR SHALL HAVE A PRECONSTRUCTION MEETING WITH OWNER TO DISCUSS ALL ASPECTS OF THE CONSTRUCTION SCOPE OF THIS DRAWING TO ENSURE HE IS FAMILIAR AND UNDERSTANDS ALL REQUIREMENTS AND INTENT OF EACH ACTIVITY.
- 13. THE GENERAL CONTRACTOR MUST VERIFY ALL DIMENSIONS, CONDITIONS AND ELEVATIONS BEFORE STARTING WORK. ALL DISCREPANCIES SHALL BE CALLED TO THE ATTENTION OF THE ENGINEER AND SHALL BE RESOLVED BEFORE PROCEEDING WITH THE WORK, ALL WORK SHALL BE PERFORMED IN A WORKMANLIKE MANNER IN ACCORDANCE WITH ACCEPTED CONSTRUCTION PRACTICES.
- 14. IT IS THE INTENTION OF THESE DRAWINGS TO SHOW THE COMPLETE INSTALLATION. THE CONTRACTOR SHALL BE RESPONSIBLE FOR ALL TEMPORARY BRACING, SHORING, TIES, FORMWORK, ETC. IN ACCORDANCE WITH ALL NATIONAL, STATE AND LOCAL ORDINANCES. TO SAFELY EXECUTE ALL WORK AND SHALL BE RESPONSIBLE FOR SAME. ALL WORK SHALL BE IN ACCORDANCE WITH LOCAL CODES.
- 15. THE CONTRACTOR SHALL USE ADEQUATE NUMBERS OF SKILLED WORKMEN WHO ARE THOROUGHLY TRAINED AND EXPERIENCED IN THE NECESSARY CRAFTS, AND WHO ARE COMPLETELY FAMILIAR WITH THE SPECIFIED REQUIREMENTS AND METHODS NEEDED FOR PROPER PERFORMANCE OF THE WORK.
- 16. CONSTRUCTION CONTRACTOR AGREES THAT IN ACCORDANCE WITH GENERALLY ACCEPTED CONSTRUCTION PRACTICES, CONSTRUCTION CONTRACTOR WILL BE REQUIRED TO ASSUME SOLE AND COMPLETE RESPONSIBILITY FOR JOB SITE CONDITIONS DURING THE COURSE OF CONSTRUCTION OF THE PROJECT, INCLUDING SAFETY OF ALL PERSONSAND PROPERTY, THAT THIS REQUIREMENT SHALL BE MADE TO APPLY CONTINUOUSLY AND NOT BE LIMITED TO NORMAL WORKING HOURS. AND CONSTRUCTION CONTRACTOR FURTHER AGREES TO INDEMNIFY AND HOLD DESIGN ENGINEER HARMLESS FROM ANY AND ALL LIABILITY, REAL OR ALLEGED, IN CONNECTION WITH PERFORMANCE OF WORK ON THIS PROJECT. ALL WORK SHALL COMPLY WITH OSHA AND STATE SAFETY REQUIREMENTS. PROCEDURES FOR THE PROTECTION OF EXCAVATIONS. EXISTING CONSTRUCTION AND UTILITIES SHALL BE ESTABLISHED PRIOR TO FOUNDATION INSTALLATION.

SITE WORK GENERAL NOTES:

- 1. THE CONTRACTOR SHALL CONTACT UTILITY LOCATING SERVICES PRIOR TO THE START
- ALL EXISTING ACTIVE SEWER, WATER, GAS, ELECTRIC, AND OTHER UTILITIES WHERE ENCOUNTERED IN THE WORK, SHALL BE PROTECTED AT ALL TIMES, AND WHERE REQUIRED FOR THE PROPER EXECUTION OF THE WORK. SHALL BE RELOCATED AS DIRECTED BY ENGINEER. EXTREME CAUTION SHOULD BE USED BY THE CONTRACTOR WHEN EXCAVATION OR DRILLING PIERS AROUND OR NEAR UTILITIES. CONTRACTOR SHALL PROVIDE SAFETY TRAINING FOR THE WORKING CREW. THIS WILL INCLUDE BUT NOT BE LIMITED TO A) FALL PROTECTION B) CONFINED SPACE C) ELECTRICAL SAFETY D) TRENCHING & EXCAVATION.
- ALL SITE WORK SHALL BE AS INDICATED ON THE DRAWINGS AND PROJECT SPECIFICATIONS.
- IF NECESSARY, RUBBISH, STUMPS, DEBRIS, STICKS, STONES AND OTHER REFUSE SHALL BE REMOVED FROM THE SITE AND DISPOSED OF LEGALLY.
- ALL EXISTING INACTIVE SEWER, WATER, GAS, FLECTRIC AND OTHER UTILITIES, WHICH INTERFERE WITH THE EXECUTION OF THE WORK, SHALL BE REMOVED AND/OR CAPPED. PLUGGED OR OTHERWISE DISCONTINUED AT POINTS WHICH WILL NOT INTERFERE WITH THE EXECUTION OF THE WORK, SUBJECT TO THE APPROVAL OF OWNER AND/OR
- THE CONTRACTOR SHALL PROVIDE SITE SIGNAGE IN ACCORDANCE WITH THE TECHNICAL SPECIFICATION FOR SITE SIGNAGE.
- THE SITE SHALL BE GRADED TO CAUSE SURFACE WATER TO FLOW AWAY FROM THE BTS EQUIPMENT AND TOWER AREAS.
- NO FILL OR EMBANKMENT MATERIAL SHALL BE PLACED ON FROZEN GROUND. FROZEN MATERIALS, SNOW OR ICE SHALL NOT BE PLACED IN ANY FILL OR EMBANKMENT.
- THE SUB GRADE UNDER THE PROPOSED EQUIPMENT PAD SHALL BE COMPACTED TO 98% PROCTOR AND BROUGHT TO A SMOOTH UNIFORM GRADE PRIOR TO FINISHED SURFACE APPLICATION
- THE AREAS OF THE OWNERS PROPERTY DISTURBED BY THE WORK AND NOT COVERED BY THE TOWER, EQUIPMENT OR DRIVEWAY, SHALL BE GRADED TO A UNIFORM SLOPE. AND STABILIZED TO PREVENT EROSION AS SPECIFIED IN THE PROJECT SPECIFICATIONS.
- CONTRACTOR SHALL MINIMIZE DISTURBANCE TO EXISTING SITE DURING CONSTRUCTION. FROSION CONTROL MEASURES IF REQUIRED DURING CONSTRUCTION SHALL BE IN CONFORMANCE WITH THE LOCAL GUIDELINES FOR EROSION AND SEDIMENT CONTROL.

STRUCTURAL STEEL NOTES:

- ALL WELDING SHALL BE PERFORMED USING E70XX ELECTRODES AND WELDING SHALL CONFORM TO AISC. WHERE FILLET WELD SIZES ARE NOT SHOWN, PROVIDE THE MINIMUM SIZE PER TABLE J2.4 IN THE AISC "MANUAL OF STEEL CONSTRUCTION". PAINTED OR GALVANIZED SURFACES SHALL BE TOUCHED UP.
- BOLTED CONNECTIONS SHALL BE ASTM A325 BEARING TYPE CONNECTIONS AND SHALL HAVE MINIMUM OF TWO BOLTS UNLESS NOTED OTHERWISE.

verizon



f | 770.368.1944

3740 Davinci Ct.

Suite 100 Peachtree Corners, GA 30092

CONCRETE AND REINFORCING STEEL NOTES:

- ALL CONCRETE WORK SHALL BE IN ACCORDANCE WITH ACI 301, ACI 318, ACI 336,
- 2. ALL CONCRETE SHALL HAVE A MINIMUM COMPRESSIVE STRENGTH OF 4000 PSI AT 28 DAYS. UNLESS NOTED OTHERWISE; SLUMP: 2" MIN. /4" MAX; AIR ENTRAINMENT: 45 TO 6% BY VOLUME; MAXIMUM COARSE AGGREGATE SIZE SHALL BE 1"
- REINFORCING STEEL SHALL CONFORM TO ASTM A 615, GRADE 60, DEFORMED UNLESS NOTED OTHERWISE. WELDED WIRE FABRIC SHALL CONFORM TO ASTM A 185 WELDED STEEL WIRE REINFORCEMENT UNLESS NOTED OTHERWISE. SPLICES SHALL BE CLASS "B" AND ALL HOOKS SHALL BE STANDARD, UNLESS NOTED OTHERWISE.
- 4. THE FOLLOWING MINIMUM CONCRETE COVER SHALL BE PROVIDED FOR REINFORCING STEEL UNLESS SHOWN OTHERWISE ON DRAWINGS:

CONCRETE CAST AGAINST EARTH.. CONCRETE EXPOSED TO EARTH OR WEATHER: #6 AND LARGER.... #5 AND SMALLER & WWF. CONCRETE NOT EXPOSED TO EARTH OR WEATHER OR NOT CAST AGAINST THE GROUND: SLAB AND WALL BEAMS AND COLUMNS .. 116

- A CHAMFER OF 3/4" SHALL BE PROVIDED AT ALL EXPOSED EDGES OF CONCRETE, UNLESS NOTED OTHERWISE, IN ACCORDANCE WITH ACI 301.
- INSTALLATION OF CONCRETE EXPANSION/WEDGE ANCHOR SHALL BE PER MANUFACTURER'S WRITTEN RECOMMENDED PROCEDURE. THE ANCHOR BOLT, DOWEL OR ROD SHALL CONFORM TO MANUFACTURER'S RECOMMENDATION FOR EMBEDMENT DEPTH OR AS SHOWN ON THE DRAWINGS. IF DRILLING IN EXISTING CONCRETE, NO EXISTING REBAR WILL BE CUT WITHOUT PRIOR ENGINEERING APPROVAL.
- WELDING IS PROHIBITED ON REINFORCING STEEL AND EMBEDMENTS
- ALL CONCRETE SHALL BE READY-MIXED IN ACCORDANCE WITH ASTM C94. MAINTAIN TEMPERATURE OF CAST IN PLACE CONCRETE AT BETWEEN 50 DEGREES AND 90 DEGREES FARENHEIT.
- 9. DO NOT USE RETEMPERED CONCRETE, OR ADD WATER TO READY-MIX CONCRETE AT
- 10. FOUNDATION INSTALLER SHALL INSURE THAT ALL PROTRUDING THREADS OF PROPOSED ANCHOR BOLTS SHALL BE MAINTAINED CLEAN AND FREE OF CONCRETE
- FOUNDATION DESIGN IS BASED ON SOIL WITH 2000 PSF BEARING CAPACITY. IF EXISTING SOIL DOES NOT HAVE A MINIMUM 2000 PSF BEARING CAPACITY CONTRACTOR SHALL EXTEND PERIMETER BEAM TO REACH SOIL WITH MINIMUM 2000 PSF BEARING



PROJECT:

HALLWAY 318965

LOCATED AT: 5182 ODUM SMALLWOOD RD GAINESVILLE, GA 30506

APPR	ROVALS
CARRIER	
LANDLORD	
LEASING	
CONSTRUCTION	
REVISIONS	DATE
ISSUED FOR:	PERMIT/CONSTRUCTION
PROJECT MANAGER:	<u>.</u>
DRAWING BY:	ALK

CONSTRUCTION NOTES

02/07/20

T-2

1010.001

JOB/FILE NUMBER:

SHEET NUMBER:

DATE

TITLE:



TOWER OWNER'S NAME:

SITE NAME: ADDRESS:

10300 OLD ALABAMA ROAD ALPHARETTA, GA 30022

FCC REGISTRATION NUMBER:

FOR LEASING INFORMATION 1-800-852-2671

IN CASE OF EMERGENCY

NO TRESPASSING

POSTING OF THE SIGN REQUIRED BY LAW

OWNER CONTACT SIGN

WHITE BACKGROUND, BLACK LETTERING. MOUNTING LOCATION: GATE



AUTHORIZED PERSONNEL SIGN

WHITE/BLUE BACKGROUND, WHITE/BLACK LETTERING. MOUNTING LOCATION: GATE & BASE OF TOWER. WHERE ACCESS GATE INSTALLED (QTY. 2)

INFORMATION Federal Communications Commission **Tower Registration Number** 1234567 Commission rules on antenna tower registration 47 CFR 17.4(g).

12"

FCC REGISTRATION SIGN

WHITE/GREEN BACKGROUND, WHITE/BLACK LETTERING. MOUNTING LOCATION: GATE & BASE OF TOWER.



WHITE/BLACK BACKGROUND, WHITE/BLACK LETTERING. MOUNTING LOCATION: GATE & BASE OF TOWER.



NOTICE RF SIGN (BLUE)

WHITE/BLUE BACKGROUND, WHITE/BLACK LETTERING. MOUNTING LOCATION: GATE & CENTERLINE OF FENCING AROUND SITE. (QTY. 4) WHERE ACCESS GATE INSTALLED (QTY. 5)





3740 Davinci Ct. Suite 100 f 770.368.1944 Peachtree Corners, GA 30092

SEAL: No. 26868 PROFESSIONAL

PROJECT:

TITLE:

SHEET NUMBER:

HALLWAY 318965

LOCATED AT: 5182 ODUM SMALLWOOD RD

APPR	OVALS
CARRIER	
LANDLORD	
LEASING	
CONSTRUCTION	
REVISIONS	DATE
ISSUED FOR:	PERMIT/CONSTRUCTION
PROJECT MANAGER:	MWM
DRAWING BY:	ALK
DATE:	02/07/20


SITE SIGNAGE

T-3

JOB/FILE NUMBER: 1010.001

DANGER NO TRESPASSING SIGN

WHERE ACCESS GATE INSTALLED (QTY. 2)

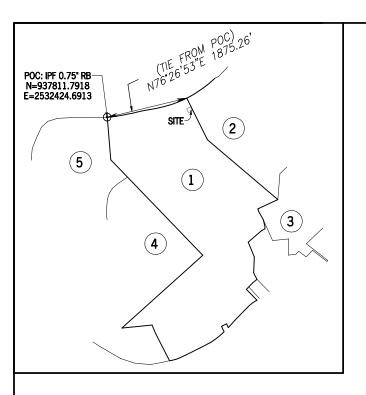

SITE INFORMATION

LEASE AREA = 10,000 SQUARE FEET (0.2296 ACRES) LATITUDE = 32°34'35.27" (NAD 83) (32.576464°) LONGITUDE = -83°23'41.65" (NAD 83) (-83.394903°) AT CENTER OF LEASE AREA

ELEVATION AT CENTER OF LEASE AREA = 474.1' A.M.S.L.

W. 470.85 Q UP TELCO

5 RWPERDB 95 PG ANT

EASEMENT FOR

CONSTRUCTION

OF DRIVES

SITE _

WILLIAM GRESSEGRESS, FIBER

MAKES TO BE ACQUIRED TO BE ACCUIRED TO BE ACQUIRED TO BE ACCUIRED TO BE ACCUIRED

10. ALIVITY

POB: UTIL 2

POB: UTIL 1

5.32

EDGE OF FIELD

CA 10'UTILITY
EASEMENT AT ACCOUNTED

526°18′14″E

sko-

EDGE OF FIELD

RIM INE PER DEED BOOM 941 PAGE 231

VICINITY MAP

THIS EXHIBIT SURVEY IS FOR THE LEASED PREMISES AND EASEMENTS ONLY. THIS EXHIBIT SURVEY WAS PREPARED FOR THE EXCLUSIVE USE OF VERIZON WIRELESS AND EXCLUSIVELY FOR THE TRANSFERRAL OF THE PROPOSED LEASED PREMISES AND THE RIGHTS OF EASEMENT SHOWN HEREON AND SHALL NOT BE USED AS AN EXHIBIT OR EVIDENCE IN THE FEE SIMPLE TRANSFERRAL OF THE PARENT PARCEL NOR ANY PORTION OR PORTIONS THEREOF, BOUNDARY INFORMATION SHOWN HEREON HAS BEEN COMPILED

THIS DRAWING DOES NOT REPRESENT A BOUNDARY SURVEY.

THE 1' CONTOURS AND SPOT ELEVATIONS SHOWN ON THIS EXHIBIT SURVEY ARE ADJUSTED TO NAVD 88 DATUM (COMPUTED USING GEOID 12B) AND HAVE A VERTICAL ACCURACY OF \pm 0.5'. CONTOURS OUTSIDE THE IMMEDIATE SITE

NO PORTION OF THIS PROPERTY IS LOCATED IN A SPECIAL FLOOD AREA AS PER F.I.R.M. COMMUNITY PANEL NO. 13289C0225B DATED 12/17/2010.

NO WETLAND AREAS HAVE BEEN INVESTIGATED BY THIS EXHIBIT SURVEY.

ALL ZONING INFORMATION SHOULD BE VERIFIED WITH THE PROPER ZONING

ANY UNDERGROUND UTILITIES SHOWN HAVE BEEN LOCATED FROM ABOVE GROUND FIELD SURVEY INFORMATION. THE SURVEYOR MAKES NO GUARANTEES THAT ANY UNDERGROUND UTILITIES SHOWN COMPRISE ALL SUCH UTILITIES IN THE AREA, EITHER IN-SERVICE OR ABANDONED. THE SURVEYOR FURTHER DOES NOT WARRANT THAT ANY UNDERGROUND UTILITIES SHOWN ARE IN THE EXACT LOCATION INDICATED ALTHOUGH THEY ARE LOCATED AS ACCURATELY AS POSSIBLE FROM INFORMATION AVAILABLE. THE SURVEYOR HAS NOT PHYSICALLY LOCATED ANY UNDERGROUND UTILITIES.

CERTIFICATE OF AUTHORIZATION: LSF000843

NOT TO SCALE

GENERAL NOTES

FROM TAX MAPS AND DEED DESCRIPTIONS ONLY. NO BOUNDARY SURVEY OF THE PARENT PARCEL WAS PERFORMED.

THE FIELD DATA UPON WHICH THIS EXHIBIT SURVEY IS BASED HAS A CLOSURE PRECISION OF ONE FOOT IN 20,000+ FEET AND AN ANGULAR ERROR OF 5.0' PER ANGLE POINT AND WAS ADJUSTED USING LEAST SQUARES.

EQUIPMENT USED FOR ANGULAR & LINEAR MEASUREMENTS: LEICA TPS 1200 ROBOTIC & GEOMAX ZENITH 35. [DATE OF LAST FIELD VISIT: 11-07-2018]

BEARINGS SHOWN ON THIS EXHIBIT SURVEY ARE BASED ON GRID NORTH (NAD

SUBJECT PROPERTY

OWNER: MONICA FAULK PADGETT F/K/A MONICA F. RHODES AND MARK SHINE FAULK

SITE ADDRESS: HIGHWAY 96, JEFFERSONVILLE, GA 31044

PARCEL ID: T087 044

AREA: 256.22 ACRES (PER TAX ASSESSOR)

ALL ZONING INFORMATION SHOULD BE VERIFIED WITH THE PROPER ZONING OFFICIALS

REFERENCES: DEED BOOK T PAGE 156

PARCEL INFORMATION

#	OWNER	PID	REFERENCE
1	MONICA FAULK PADGETT	T087 044	DBT PG 156
2	MARK B FAULK	T087 045	DB RR PG 278
3	CHARLES ROY ASBELL & GLEN RAY ASBELL	T106 001	DB 61 PG 453
4	GLADYS B FAULK ESTATE	T088 023	DB 4L PG 299
5	MONICA F. RHODES & MARK S. FAULK	T087 042	DB 4L PG 299

GPS NOTES

THE FOLLOWING GPS STATISTICS UPON WHICH THIS SURVEY IS BASED HAVE BEEN PRODUCED AT THE 95% CONFIDENCE LEVEL:

POSITIONAL ACCURACY: 0.06 FEET (HORZ) 0.12 FEET (VERT)
TYPE OF EQUIPMENT: GEOMAX ZENITH35 PRO BASE AND ROVER, DUAL FREQUENCY
TYPE OF GPS FIELD PROCEDURE: ONLINE POSITION USER INTERFACE DATES OF SURVEY: 11-07-2018

DATUM / EPOCH: NAD_83(2011)(EPOCH:2010.0000)

PUBLISHED / FIXED CONTROL USE: DN7486, DE9144, DH4140 GEOID MODEL: 12B COMBINED GRID FACTOR(S): 0.99994624 CENTERED ON THE GPS BASE POINT AS SHOWN HEREON. CONVERGENCE ANGLE: 00°24'55.86'

LEGENU
POB POINT OF BEGINNING
POC POINT OF COMMENCIEMENT
IPS ROON PIN SET
IPF RON PIN SET
IPF RON PIN FOUND
CMF CONCRETE MONUMENT FOUND
UP UTLITY POLE
GW GUY WINE
TS TOP OF SLOPE
BS BOTTOM OF SLOPE
SD SIGHT DISTANCE
RCP REINFORCED CONCRETE PIPE
CMP CORRUGATED METAL PIPE
INV INVERT
IPP EDEC OF PAVEMENT
TBM TEMPORARY BENCH MARK

LINE TABLE

2 4	78 53				OF DRIVES (DB 9-S PG 447) EASEMENT FOR —	GRS BASE & T GREEN: 475 GREEN:	BM 12 P3
	99 99				5 CONSTRUCTION	RESSENT#1	
			LINE TAB	<u>BLE</u>	5 CONSTRUCTION OF SLOPES (DB 9-S PG 447) WGRESSEGF WGRESSEGF	RESS FIBERY ASEMENT TO BE ACQUIRED N63,41,46,"E	AL P.
	LINI	E	BEARING	DISTANCE		14. 100.	λ
		_ 1	S26°24'55"E	137.27'		N26·18·14·"W	/ \
		.2	S06°22'08"E	85.00'		26.18,14,	/\
		.3	S63°41'46"W			N20100.00	
		.4	N06°21'44"W			LEASE AREA	_ \
		.5	N19°48'51"W			LEASE AREA ROUME	וס
		.6	N29°29'38"W			LEAS TO BE NO	
		.7	N63°26'50"E			RIGHTS	563°41'4
		.8	N63°07'19"E				563,00.0
		.9	S29°29'38"E	34.92'			10
	L1	\rightarrow	S19°48'51"E	62.74'			
	L1	\rightarrow	S06°20'55"E				
	L1	_	N26°24'55"W N06°22'08"W				
	L1	\rightarrow					
	L 1	4	N06°22'08"W	53.21			

GRAPHIC SCALE IN FEET SCALE: 1" = 80'

SURVEY NOT VALID WITHOUT SHEET 2 OF 2

EXHIBIT SURVEY PREPARED FOR:

FAULK LAKE

25TH DISTRICT TWIGGS COUNTY, GEORGIA

DRAWN BY: AKG

CHECKED BY: JKL APPROVED: C. INER

DATE: NOVEMBER 28, 2018.

P2P JOB #: 184454GA

SHEET:

1010 Pennsylvania Avenue McDonough, GA 30253 (p) 678.565.4440 McDonough, (p) 678.565.4 (f) 678.565.4

CEORG!

No. 2966

TALES LEE

6/28/19

02/14/19 LANGUAGE ESMT-AKG ADDED TITLE - NRW

REVISION

NO.

DATE

POIN

06/28/19

S Δ

SURVEY

REGISTER BOY

10300 OLD ALABAMA ROAD CONNECTOR ALPHARETTA, GA 30022

LEGEND

INGRESS-EGRESS, FIBER & UTILITY EASEMENT #1

TOGETHER WITH AN INGRESS-EGRESS, FIBER AND UTILITY EASEMENT LYING AND BEING IN 25TH LAND DISTRICT, TWIGGS COUNTY, GEORGIA, AND BEING PART OF THE LANDS OWNED BY GLADYS B. FAULK ESTATE, TWIGGS COUNTY, GEORGIA, AND BEING MORE PARTICULARLY DESCRIBED AS FOLLOWS:

TO FIND THE POINT OF BEGINNING, COMMENCE AT A 0.75-INCH REBAR FOUND AT THE SOUTHERLY RIGHT-OF-WAY LINE OF HIGHWAY 96, SAID REBAR FOUND HAVING A GEORGIA GRID NORTH, NAD83, WEST ZONE VALUE OF NORTH: 937811.7918, EAST: 2532424.6913 MARKING THE NORTHWEST CORNER OF SAID LANDS; THENCE RUNNING ALONG A TIE LINE, NORTH 76°26'53" EAST, 1875.26 FEET TO A POINT ON SAID RIGHT-OF-WAY LINE AND HAVING A GEORGIA GRID NORTH, NAD83, WEST ZONE VALUE OF NORTH: 938251.2132, EAST: 2534247.7403 AND THE TRUE POINT OF BEGINNING; THENCE LEAVING SAID RIGHT-OF-WAY LINE AND RUNNING ALONG THE WEST LINE OF THE LANDS OWNED BY MARK B. FAULK, AS RECORDED IN DEED BOOK RR PAGE 278, SOUTH 26°24'55" EAST, 137.27 FEET TO A POINT; THENCE, SOUTH 06°22'08' EAST, 85.00 FEET TO A POINT ON THE LEASE AREA; THENCE RUNNING ALONG SAID LEASE AREA, SOUTH 63°41'46" WEST, 31.91 FEET TO A POINT; THENCE LEAVING SAID LEASE AREA AND RUNNING, NORTH 06°21'44" WEST, 135.18 FEET TO A POINT; THENCE, NORTH 19°48'51" WEST, 56.66 FEET TO A POINT: THENCE, NORTH 29°29'38" WEST, 33.81 FEET TO A POINT ON SAID RIGHT-OF-WAY LINE; THENCE RUNNING ALONG SAID RIGHT-OF-WAY LINE, NORTH 63°26'50' EAST, 10.00 FEET TO A POINT AND THE POINT OF BEGINNING.

BEARINGS ARE BASED ON GEORGIA GRID NORTH, NAD83, WEST ZONE.

SAID TRACT CONTAINS 0.1056 ACRES (4,600 SQUARE FEET), MORE OR LESS.

INGRESS-EGRESS, FIBER & UTILITY EASEMENT #2

TOGETHER WITH AN INGRESS-EGRESS, FIBER AND UTILITY EASEMENT LYING AND BEING IN 25TH LAND DISTRICT, TWIGGS COUNTY, GEORGIA, AND BEING PART OF THE LANDS OWNED BY MARK B, FAULK, AS RECORDED IN DEED BOOK RR PAGE 278, TWIGGS COUNTY, GEORGIA, AND BEING MORE PARTICULARLY **DESCRIBED AS FOLLOWS:**

TO FIND THE POINT OF BEGINNING, COMMENCE AT A 0.75-INCH REBAR FOUND AT THE SOUTHERLY RIGHT-OF-WAY LINE OF HIGHWAY 96, SAID REBAR FOUND HAVING A GEORGIA GRID NORTH, NAD83, WEST ZONE VALUE OF NORTH: 937811.7918, EAST: 2532424.6913 MARKING THE NORTHWEST CORNER OF THE LANDS OWNED BY GLADYS B. FAULK ESTATE: THENCE RUNNING ALONG A TIE LINE, NORTH 76°26'53" EAST. 1875.26 FEET TO A POINT ON SAID RIGHT-OF-WAY LINE AND HAVING A GEORGIA GRID NORTH, NAD83, WEST ZONE VALUE OF NORTH: 938251.2132, EAST: 2534247.7403 AND THE TRUE POINT OF BEGINNING; THENCE RUNNING ALONG SAID RIGHT-OF-WAY LINE, NORTH 63°07'19" EAST, 20.03 FEET TO A POINT; THENCE, SOUTH 29°29'38' EAST, 34.92 FEET TO A POINT; THENCE, SOUTH 19°48'51' EAST, 62.74 FEET TO A POINT; THENCE, SOUTH 06°20'55' EAST, 42.83 FEET TO A POINT ON THE EAST LINE OF THE LANDS OWNED BY GLADYS B. FAULK ESTATE; THENCE RUNNING ALONG SAID EAST LINE, NORTH 26°24'55" WEST, 137,27 FEET TO A POINT ON SAID RIGHT-OF-WAY AND THE POINT OF BEGINNING.

BEARINGS ARE BASED ON GEORGIA GRID NORTH, NAD83, WEST ZONE.

SAID TRACT CONTAINS 0.0497 ACRES (2,166 SQUARE FEET), MORE OR LESS.

LEASE AREA

ALL THAT TRACT OR PARCEL OF LAND LYING AND BEING IN 25TH LAND DISTRICT. TWIGGS COUNTY. GEORGIA, AND BEING PART OF THE LANDS OWNED BY GLADYS B. FAULK ESTATE, TWIGGS COUNTY, GEORGIA, AND BEING MORE PARTICULARLY DESCRIBED AS FOLLOWS:

TO FIND THE POINT OF BEGINNING, COMMENCE AT A 0.75-INCH REBAR FOUND AT THE SOUTHERLY RIGHT-OF-WAY LINE OF HIGHWAY 96, SAID REBAR FOUND HAVING A GEORGIA GRID NORTH, NAD83, WEST ZONE VALUE OF NORTH: 937811.7918, EAST: 2532424.6913 MARKING THE NORTHWEST CORNER OF SAID LANDS: THENCE RUNNING ALONG A TIE LINE, NORTH 76°26'53" EAST, 1875.26 FEET TO A POINT ON SAID RIGHT-OF-WAY LINE AND HAVING A GEORGIA GRID NORTH, NAD83, WEST ZONE VALUE OF NORTH: 938251.2132, EAST: 2534247.7403; THENCE LEAVING SAID RIGHT-OF-WAY LINE AND RUNNING THROUGH THE LANDS OWNED BY MARK B. FAULK, AS RECORDED IN DEED BOOK RR PAGE 278. LEAVING SAID RIGHT-OF-WAY LINE AND RUNNING ALONG THE WEST LINE OF THE LANDS OWNED BY MARK B. FAULK, AS RECORDED IN DEED BOOK RR PAGE 278, SOUTH 26°24'55" EAST. 137.27 FEET TO A POINT; THENCE, SOUTH 06°22'08" EAST, 85.00 FEET TO A POINT ON THE LEASE AREA; THENCE RUNNING ALONG SAID LEASE AREA, NORTH 63°41'46" EAST, 19.09 FEET TO A POINT AND THE TRUE POINT OF BEGINNING; THENCE, SOUTH 26°18'14" EAST, 100.00 FEET TO A POINT; THENCE, SOUTH 63°41'46' WEST, 100.00 FEET TO A POINT; THENCE, NORTH 26°18'14' WEST, 100.00 FEET TO A POINT; THENCE, NORTH 63°41'46" EAST, 100.00 FEET TO A POINT AND THE POINT OF BEGINNING.

BEARINGS ARE BASED ON GEORGIA GRID NORTH, NAD83, WEST ZONE.

SAID TRACT CONTAINS 0.2296 ACRES (10,000 SOUARE FEET), MORE OR LESS.

LEGAL DESCRIPTION SHEET

10' UTILITY EASEMENT #1

TOGETHER WITH A 10-FOOT WIDE UTILITY EASEMENT (LYING 5 FEET EACH SIDE OF CENTERLINE) LYING AND BEING IN 25TH LAND DISTRICT, TWIGGS COUNTY, GEORGIA, AND BEING PART OF THE LANDS OWNED BY GLADYS B. FAULK ESTATE, TWIGGS COUNTY, GEORGIA, AND BEING MORE PARTICULARLY DESCRIBED BY THE FOLLOWING CENTERLINE DATA:

TO FIND THE POINT OF BEGINNING, COMMENCE AT A 0.75-INCH REBAR FOUND AT THE SOUTHERLY RIGHT-OF-WAY LINE OF HIGHWAY 96. SAID REBAR FOUND HAVING A GEORGIA GRID NORTH, NAD83. WEST ZONE VALUE OF NORTH: 937811.7918, EAST: 2532424.6913 MARKING THE NORTHWEST CORNER OF SAID LANDS; THENCE RUNNING ALONG A TIE LINE, NORTH 76°26'53" EAST, 1875.26 FEET TO A POINT ON SAID RIGHT-OF-WAY LINE AND HAVING A GEORGIA GRID NORTH, NAD83, WEST ZONE VALUE OF NORTH: 938251.2132, EAST: 2534247.7403; THENCE LEAVING SAID RIGHT-OF-WAY LINE AND RUNNING THROUGH THE LANDS OWNED BY MARK B. FAULK, AS RECORDED IN DEED BOOK RR PAGE 278, SOUTH 26°24'55" EAST, 137.27 FEET TO A POINT; THÉNCE, SOUTH 06°22'08" EAST, 85,00 FEET TO A POINT ON THE LEASE AREA: THENCE RUNNING ALONG SAID LEASE AREA, NORTH 63°41'46" EAST, 5.32 FEET TO A POINT AND THE TRUE POINT OF BEGINNING; THENCE LEAVING SAID LEASE AREA AND RUNNING, NORTH 06°22'08" WEST, 69.49 FEET TO THE ENDING AT A POINT ON WEST LINE OF THE LANDS OWNED BY MARK B. FAULK, AS RECORDED IN DEED BOOK RR PAGE 278.

BEARINGS ARE BASED ON GEORGIA GRID NORTH, NAD83, WEST ZONE.

10' UTILITY EASEMENT #2

TOGETHER WITH A 10-FOOT WIDE UTILITY EASEMENT (LYING 5 FEET EACH SIDE OF CENTERLINE) LYING AND BEING IN 25TH LAND DISTRICT, TWIGGS COUNTY, GEORGIA, AND BEING PART OF THE LANDS OWNED BY MARK B. FAULK, AS RECORDED IN DEED BOOK RR PAGE 278, TWIGGS COUNTY RECORDS, TWIGGS COUNTY, GEORGIA, AND BEING MORE PARTICULARLY DESCRIBED BY THE FOLLOWING CENTERLINE DATA:

TO FIND THE POINT OF BEGINNING, COMMENCE AT A 0.75-INCH REBAR FOUND AT THE SOUTHERLY RIGHT-OF-WAY LINE OF HIGHWAY 96, SAID REBAR FOUND HAVING A GEORGIA GRID NORTH, NAD83, WEST ZONE VALUE OF NORTH: 937811.7918, EAST: 2532424.6913 MARKING THE NORTHWEST CORNER OF THE LANDS OWNED BY GLADYS B. FAULK ESTATE; THENCE RUNNING ALONG A TIE LINE, NORTH 76°26'53' EAST, 1875.26 FEET TO A POINT ON SAID RIGHT-OF-WAY LINE AND HAVING A GEORGIA GRID NORTH, NAD83, WEST ZONE VALUE OF NORTH: 938251.2132, EAST: 2534247.7403; THENCE LEAVING SAID RIGHT-OF-WAY LINE AND RUNNING THROUGH THE LANDS OWNED BY MARK B. FAULK, AS RECORDED IN DEED BOOK RR PAGE 278, SOUTH 26°24'55" EAST, 137.27 FEET TO A POINT; THENCE, SOUTH 06°22'08" EAST, 85.00 FEET TO A POINT ON THE LEASE AREA; THENCE RUNNING ALONG SAID LEASE AREA, NORTH 63°41'46" EAST, 5.32 FEET TO A POINT; THENCE LEAVING SAID LEASE AREA AND RUNNING, NORTH 06°22'08" WEST. 69.49 FEET TO A POINT AND THE TRUE POINT OF BEGINNING; THENCE RUNNING THROUGH SAID LANDS, NORTH 06°22'08" WEST, 53.21 FEET TO THE ENDING AT A POINT.

BEARINGS ARE BASED ON GEORGIA GRID NORTH, NAD83, WEST ZONE.

TITLE EXCEPTIONS

THIS SURVEY WAS COMPLETED WITH THE AID OF TITLE WORK PREPARED BY THE LAW FIRM OF HODGES & BELL, EFFECTIVE DATE OF MARCH 7, 2019, BEING FILE NO. H936.020, FOR THE SUBJECT PROPERTY, TO DETERMINE THE IMPACTS OF EXISTING TITLE

2. RELINQUISHMENT OF ACCESS RIGHTS (EXCEPT AS DESIGNATED BY THE DOT) AS CONTAINED IN THAT CERTAIN RIGHT OF WAY DEED FROM MONICA FAULK PADGETT F/K/A MONICA FAULK RHODES TO DEPARTMENT OF TRANSPORTATION, DATED NOVEMBER 29, 1994, FILED MAY 23, 1995 AND RECORDED IN DEED BOOK 4-W, PAGE 644, RECORDS OF THE SUPERIOR COURT OF TWIGGS COUNTY, GEORGIA

[THIS ITEM DOES NOT AFFECT THE LEASE AREA, INGRESS-EGRESS, FIBER & UTILITY EASEMENTS, OR THE UTILITY EASEMENTS].

3. EASEMENT FOR MAINTENANCE OF OUTFULL DITCH AND RELINQUISHMENT OF ACCESS RIGHTS (EXCEPT AS DESIGNATED BY THE DOT), AS CONTAINED IN THAT CERTAIN RIGHT OF WAY DEED FROM MONICA FAULK PHODES & MARK S. FAULK TO DEPARTMENT OF TRANSPORTATION, DATED NOVEMBER 29, 1994, FILED MAY 23, 1995 AND RECORDED IN DEED BOOK 4-W, PAGE 647, AFORESAID RECORDS.

[THIS ITEM DOES NOT AFFECT THE LEASE AREA, INGRESS-EGRESS, FIBER & UTILITY EASEMENTS, OR THE UTILITY EASEMENTS].

4. RELINQUISHMENT OF ACCESS RIGHTS (EXCEPT AS DESIGNATED BY THE DOTI AS CONTAINED IN THAT CERTAIN RIGHT OF WAY DEED FROM MONICA F. PADGETT F/K/A MONICA F. RHODES TO DEPARTMENT OF TRANSPORTATION, DATED AUGUST 10, 2015, FILED AUGUST 13, 2015 AND RECORDED IN DEED BOOK 9-S, PAGE 397. AFORESAID RECORDS.

[THIS ITEM DOES NOT AFFECT THE LEASE AREA, INGRESS-EGRESS, FIBER & UTILITY EASEMENTS, OR THE UTILITY EASEMENTS].

5. RELINQUISHMENT OF ACCESS RIGHTS (EXCEPT AS DESIGNATED BY THE DOT) AS CONTAINED IN THAT CERTAIN RIGHT OF WAY DEED FROM MONICA F. PADGETT AND MARK SHINE FAULK TO DEPARTMENT OF TRANSPORTATION, DATED AUGUST 10, 2015, FILED AUGUST 21, 2015 AND RECORDED IN DEED BOOK 9-S, PAGE

IPLOTTABLE ITEMS SHOWN HEREON. UNABLE TO DETEMINE AREAS OF LIMITED ACCESS].

6. CERTAIN EASEMENTS RIGHTS EFFECTIVE THROUGH JANUARY 1. 2020 AS CONTAINED IN ORDER AND JUDGMENT; RE: DOCKET NO. 2016-V-125, SUPERIOR COURT OF TWIGGS COUNTY, GEORGIA; STYLED DEPARTMENT OF TRANSPORTATION VS. 4.807 ACRES OF LAND AND CERTAIN EASEMENTS, MONICA FAULK RHODES, A/K/A MONICA PADGETT, ET AL., FILED JUNE 13, 2016 AND RECORDED JUNE 13, 2016 IN DEED BOOK 9-W, PAGE 237, AFORESAID

IPLOTTABLE ITEMS SHOWN HEREONI.


14. POWER OF ATTORNEY FROM MARK SHINE FAULK TO MONICA F. PADGETT, DATED OCTOBER 6, 2005, FILED NOVEMBER 4, 2005 AND RECORDED IN DEED BOOK 7-Q, PAGE 58, AFORESAID RECORDS.

INOT A SURVEY RELATED ITEM!

15. AS A MATTER OF INFORMATION ONLY: THE FOLLOWING INSTRUMENT WAS FOUND OF RECORD AND PROPERTY CITED THEREIN APPEARS TO BE SLIGHTLY WEST OF SUBJECT PROPERTY:

MEMORANDUM OF OPTION AND GROUND LEASE AGREEMENT RETWEEN MONICA FAULK PADGETT, F/K/A MONICA FAULK RHODES, BC PADGETT AND CANDICE SHUGART AND COMMUNICATIONS INFRASTRUCTURE GROUP, LLC, A DELAWARE LIMITED LIABILITY COMPANY, DATED SEPTEMBER 15, 2010, FILED OCTOBER 5, 2010 AND RECORDED IN DEED BOOK 8-V, PAGE 10, AFORESAID RECORDS.

[THIS ITEM APPEARS TO AFFECT PARCEL NO. T087 045. DOCUMENT DOES NOT PROVIDE A PLOTTABLE DESCRIPTION OF THE LESAE AREA

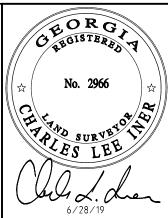

NO.	DATE	REVISION
1	02/14/19	LANGUAGE ESMT-AKG
2	06/28/19	ADDED TITLE - NRW

9 R سا ک

0

) Pennsylvania Avenue pnough, GA 30253 78.565.4440 8.565.4497 J N AND S 010 Pennsyl cDonough, (c) 678.565.4 101 McD (p) 6 (f) 6

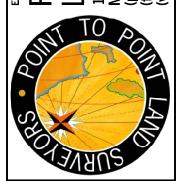


EXHIBIT SURVEY PREPARED FOR:



ALPHARETTA. GA 30022

FAULK LAKE

25TH DISTRICT TWIGGS COUNTY, GEORGIA

DRAWN BY: AKG

CHECKED BY: JKL APPROVED: C. INER

DATE: NOVEMBER 28, 2018

SURVEY NOT VALID WITHOUT SHEET 1 OF 2 P2P JOB #: 184454GA

SHEET:

EXISTING CONDITIONS ARE BASED ON A GOOGLE NOTE: THERE ARE NO AERIAL IMAGERY. CONTRACTOR SHALL FIELD VERIFY EXISTING CONDITIONS PRIOR TO EXISTING TOWERS WITHIN 1,500' OF PROPOSED TOWER. COMMENCEMENT OF CONSTRUCTION. NOTE: SETBACKS TO EXISTING STRUCTURES ARE MEASURED FROM CENTER OF PROPOSED ZONING CONDITIONS 1. THE PROPOSED TOWER SHALL BE LOCATED AS SHOWN ON THE SITE PLAN AND AS DESCRIBED IN THE NARRATIVE THAT WAS SUBMITTED. TOWER. 2. THE APPLICANT SHALL NOTIFY THE COUNTY OF ANY CONSTRUCTION, TOWER, OR SITE MODIFICATIONS THAT WOULD BE DIFFERENT FROM WHAT IS SUBMITTED FOR CONSIDERATION. OF PARTICULAR INTEREST TO THE COUNTY ARE CHANGES IN HEIGHT, STRUCTURE, TOWER LIGHTING, AND GROUND FACILITIS THAT WOULD HAVE ANY IMPACT ON THE SITES ABILITY TO SUPPORT OTHER USERS OR AFFECT THE SURROUNDING NEIGHBORHOOD. 3. THE HEIGHT OF THE TOWER AND ALL APPURTENANCES, INCLUDING LIGHTING RODS, SHALL BE LIMITED TO 195 FEET AS SHOWN ON THE PROPOSED CONSTRUCTION DRAWINGS. PROPOSED 4X TOWER 4. ALL PLANS AND PLATS CREATED FOR THIS
DEVELOPMENT SHALL REFERENCE THE CONDITIONS OF
ZONING APPROVAL.
5. APPLICANT SHALL SUBMIT EVIDENCE OF STRUCTURAL HEIGHT (780') SETBACK INTEGRITY OF THE TOWER PRIOR TO THE ISSUANCE OF ANY LAND DISTURBANCE OR BUILDING PERMITS. PROPOSED MONOPOLE TOWER **GRAPHIC SCALE** 100' 200' **TOWER SETBACK AERIAL** (SCALE IN FEET) 11x17 SCALE: 1"=200'





Foresite Group, LLC | W | www.fg-inc.net 3740 Davinci Ct. | o | 770.368.1399 Suite 100 | f | 770.368.1944 Peachtree Corners, GA 30092

SEAL: No. 26863 PROFESSIONAL

PROJECT:

DRAWING BY:

DATE:

24x36 SCALE: 1"=100'

HALLWAY 318965

LOCATED AT: 5182 ODUM SMALLWOOD RD GAINESVILLE, GA 30506


APPR	ROVALS
CARRIER	
LANDLORD	
LEASING	
CONSTRUCTION	
REVISIONS	DATE
ISSUED FOR:	PERMIT/CONSTRUCTION
PROJECT MANAGER:	MWM

TOWER SETBACK AERIAL

ALK

02/07/20

SHEET NUMBER: C-0JOB/FILE NUMBER: 1010.001

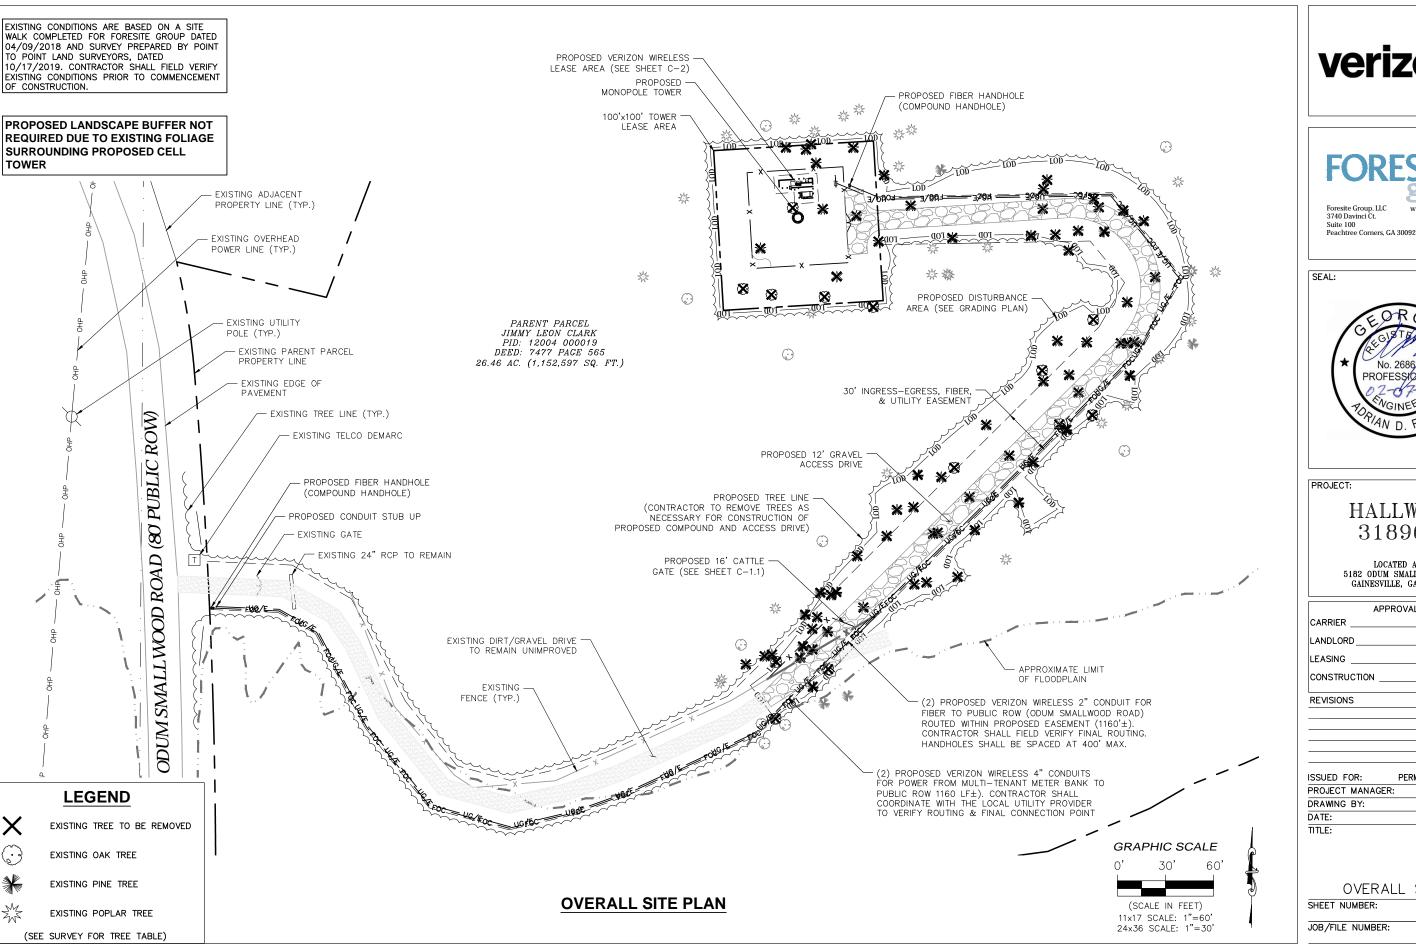





w | www.fg-inc.net o | 770.368.1399 f | 770.368.1944




HALLWAY 318965

LOCATED AT: 5182 ODUM SMALLWOOD RD GAINESVILLE, GA 30506

APPROVALS DATE

PERMIT/CONSTRUCTION MWM ALK 02/07/20

OVERALL SITE PLAN C-11010.001

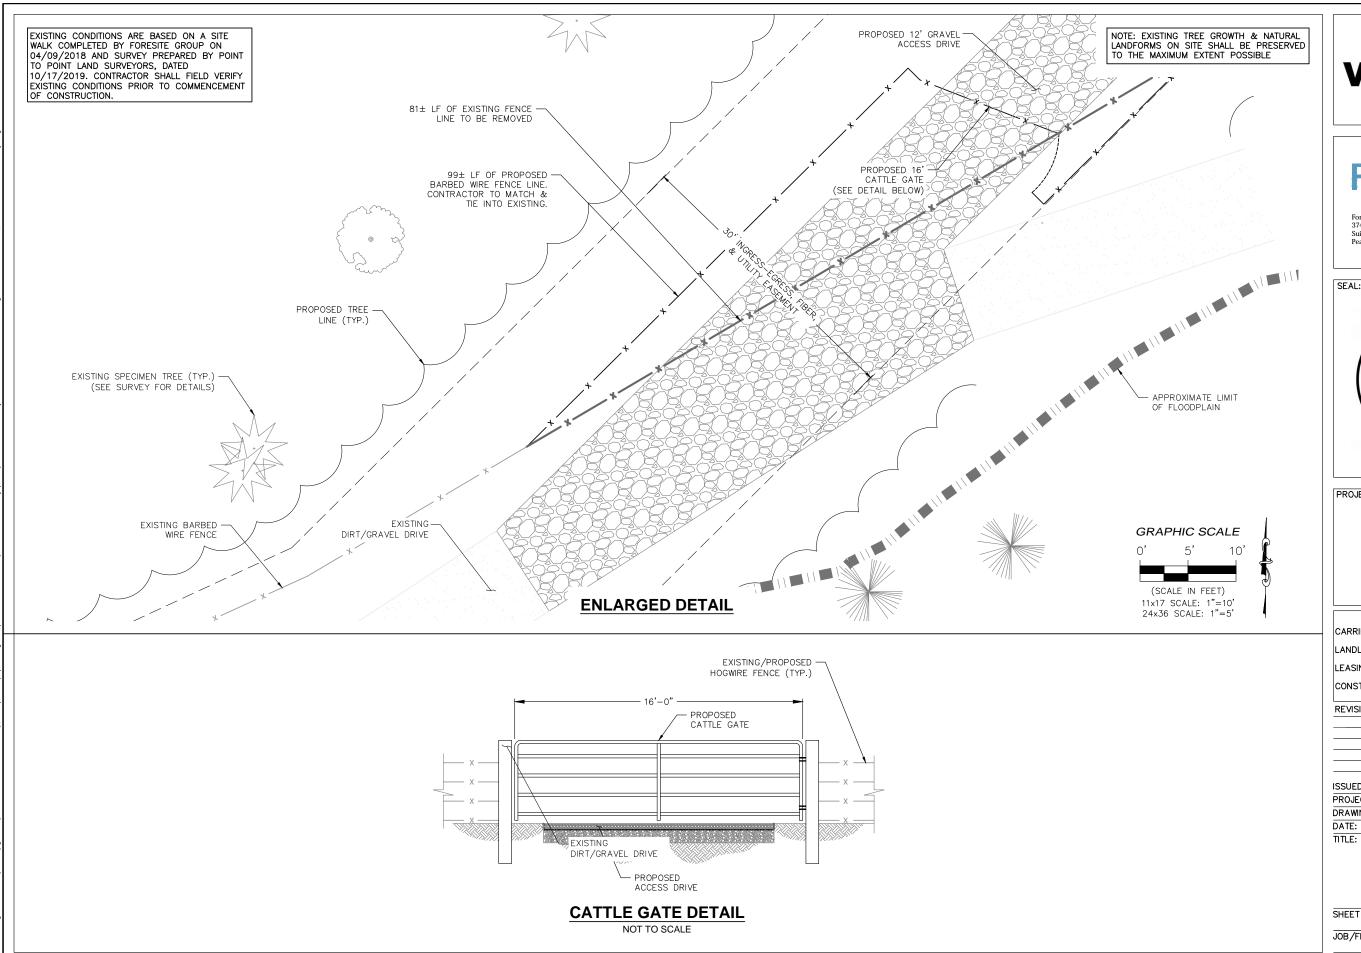







PROJECT:

HALLWAY 318965


LOCATED AT: 5182 ODUM SMALLWOOD RD GAINESVILLE, GA 30506

APPR	OVALS
CARRIER	
LANDLORD	
LEASING	
CONSTRUCTION	
REVISIONS	DATE
	DEDUKT (CONCEDUCTION
ISSUED FOR:	PERMIT/CONSTRUCTION
PROJECT MANAGER:	MWM
DRAWING BY:	ALK

ENLARGED CATTLE GATE DETAIL


02/07/20

SHEET NUMBER: C - 1.1JOB/FILE NUMBER: 1010.001

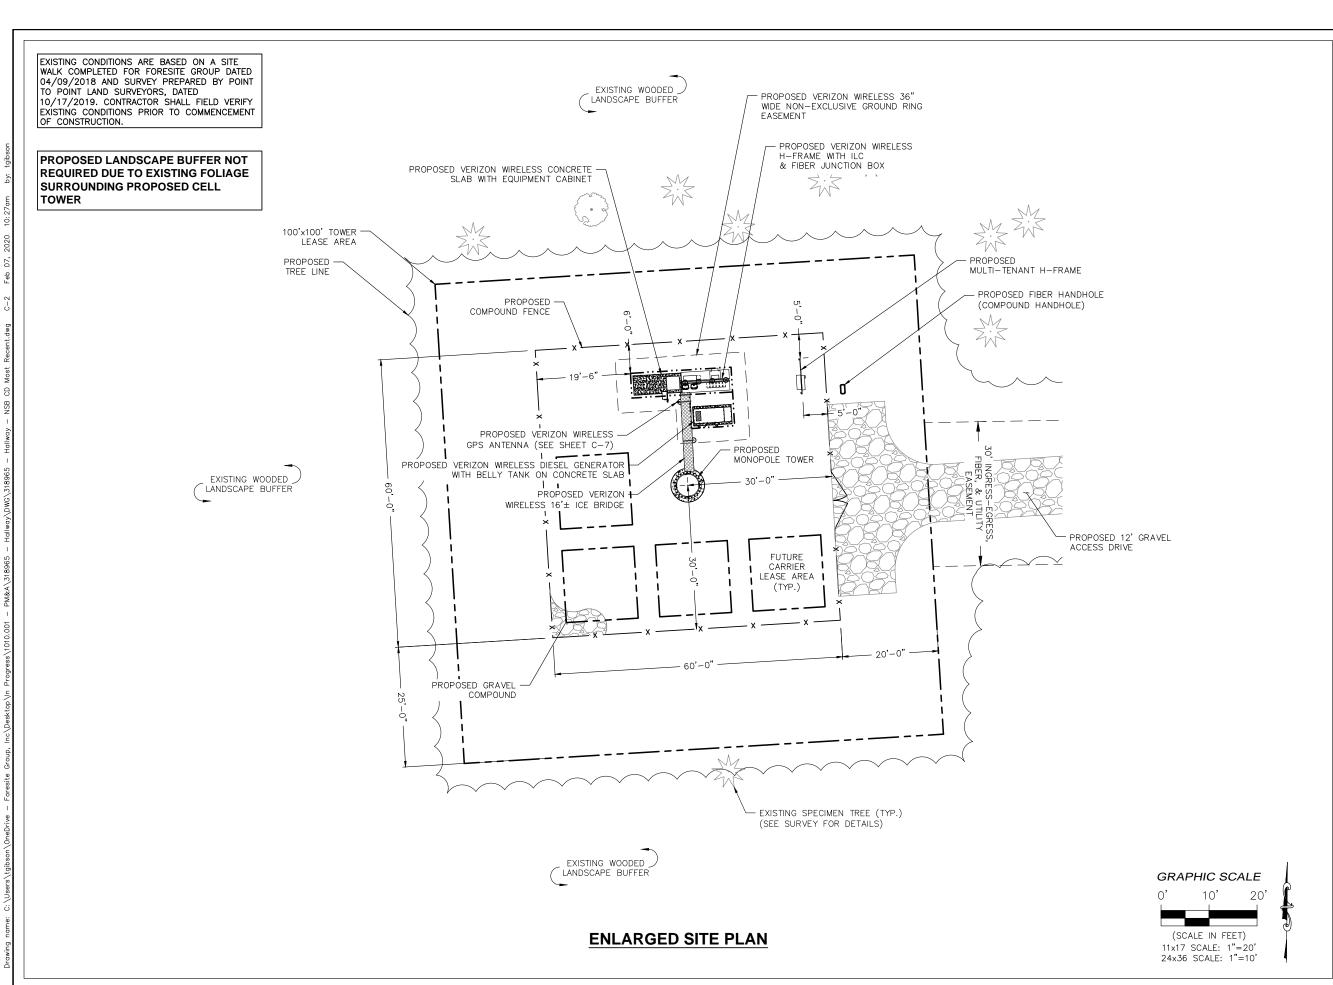





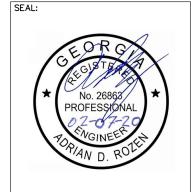

PROJECT:

DRAWING BY:

DATE:

TITLE:

HALLWAY 318965

LOCATED AT: 5182 ODUM SMALLWOOD RD GAINESVILLE, GA 30506

ADDDOV/ALC


ALL!	OVALS
CARRIER	
LANDLORD	
LEASING	
CONSTRUCTION	
REVISIONS	DATE
ISSUED FOR:	PERMIT/CONSTRUCTION
PROJECT MANAGER	MWM

ALK 02/07/20

ENLARGED SITE PLAN
SHEET NUMBER: C-2

JOB/FILE NUMBER: 1010.001

PROPOSED PROJECT DISTURBED AREA (0.84 AC; INCLUDING PROPOSED TOWER LEASE AREA AND EASEMENTS) IS DESIGNED TO NOT EXCEED 1 AC (TOTAL). PRIOR TO CONSTRUCTION, CONTRACTOR TO NOTFY ENGINEER IF ADDITIONAL IMPROVEMENTS WILL BE REQUIRED WHICH RESULT IN GREATER THAN 1 AC TOTAL DISTURBED AREA.

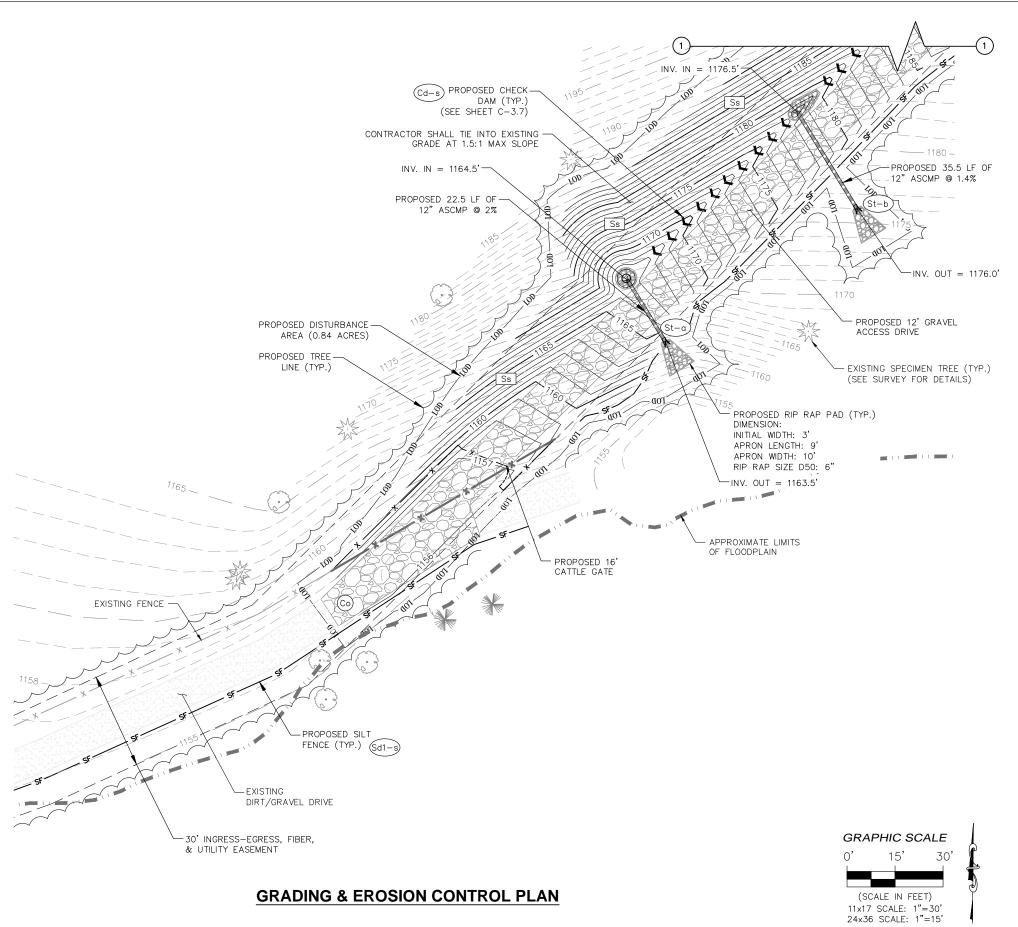





Foresite Group, LLC | w | www.fg.inc.net 3740 Davinci Ct. | o | 770.368.1399 Suite 100 | f | 770.368.1944 Peachtree Corners, GA 30092

SEAL:



PROJECT:

HALLWAY 318965

LOCATED AT: 5182 ODUM SMALLWOOD RD GAINESVILLE, GA 30506


APPROVALS	
CARRIER	
LANDLORD	
LEASING	
CONSTRUCTION	
REVISIONS	DATE

ISSUED FOR: PERMIT/CONSTRUCTION
PROJECT MANAGER: MWM
DRAWING BY: ALK
DATE: 02/07/20
TITLE:


GRADING & EROSION CONTROL PLAN

SHEET NUMBER: C-3.0

JOB/FILE NUMBER: 1010.001

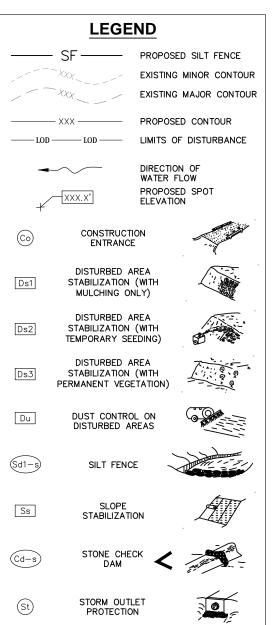

PROPOSED PROJECT DISTURBED AREA (0.84 AC; INCLUDING PROPOSED TOWER LEASE AREA AND EASEMENTS) IS DESIGNED TO NOT EXCEED 1 AC (TOTAL). PRIOR TO CONSTRUCTION, CONTRACTOR TO NOTIFY ENGINEER IF ADDITIONAL IMPROVEMENTS WILL BE REQUIRED WHICH RESULT IN GREATER THAN 1 AC TOTAL DISTURBED AREA.

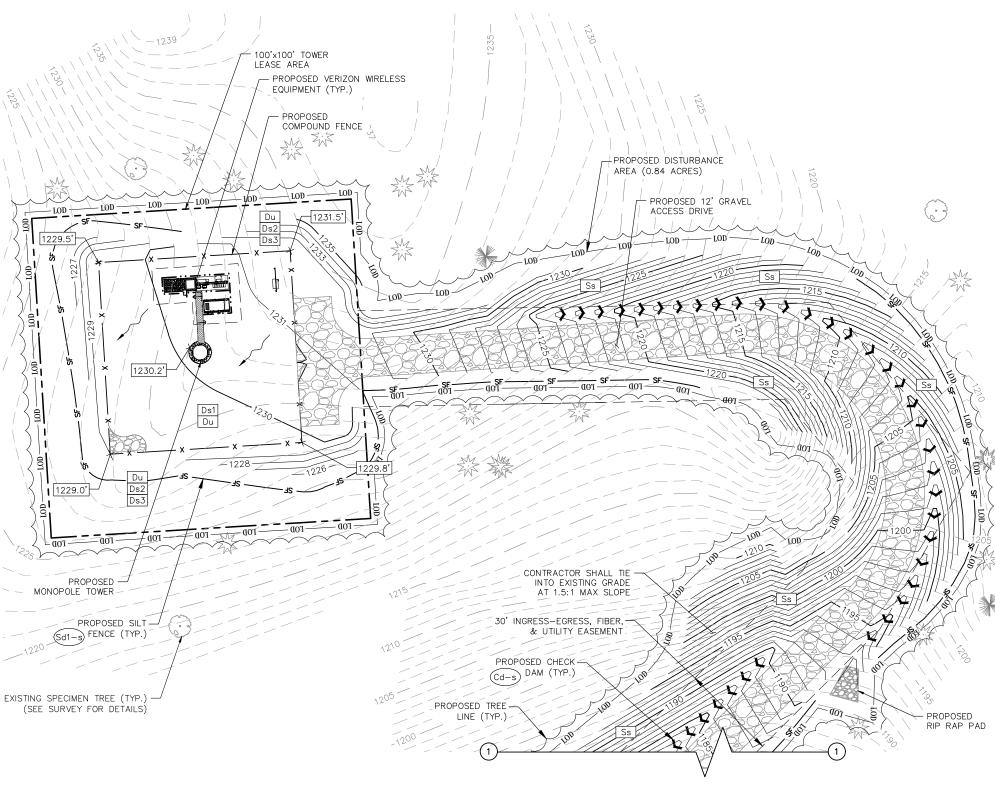

GRADING & EROSION CONTROL PLAN



Foresite Group, LLC 3740 Davinci Ct. Suite 100

w | www.fg-inc.net o | 770.368.1399 f | 770.368.1944 Peachtree Corners, GA 30092



PROJECT:

GRAPHIC SCALE 15'

(SCALE IN FEET)

11x17 SCALE: 1"=30' 24x36 SCALE: 1"=15'

30'

HALLWAY 318965

LOCATED AT: 5182 ODUM SMALLWOOD RD GAINESVILLE, GA 30506

APPROVALS CARRIER LANDLORD LEASING CONSTRUCTION REVISIONS DATE

ISSUED FOR: PERMIT/CONSTRUCTION PROJECT MANAGER: MWM DRAWING BY: ALK DATE: 02/07/20

> GRADING & EROSION CONTROL PLAN

SHEET NUMBER: C - 3.1JOB/FILE NUMBER: 1010.001

DUST CONTROL ON DISTURBED AREAS

REFER TO THE POLLUTION CONTROL NOTES FOR RECOMMENDED SEQUENCE AND PRACTICE OF DUST CONTROL MEASURES.

TEMPORARY METHODS

- 1. APPLICATION OF MULCH (SEE Ds1)
- 2. TEMPORARY VEGETATIVE COVER (SEE Ds2)
- 3. SPRAY ON ADHESIVES (SEE Tac)
- 4. TILLAGE THE ROUGHENING OF SOIL AND BRING CLODS TO THE SURFACE. IT SHOULD BE USED AS AN EMERGENCY MEASURE BEFORE HIGH WIND EROSION
- 5. IRRIGATION - SPRINKLE WITH WATER UNTIL THE SURFACE IS WET. REPEAT AS
- 6. BARRIERS SOLID BOARD FENCES, SNOW FENCES, BURLAP FENCES, BALES OF HAY, AND SIMILAR MATERIALS TO BE PLACED TO RIGHT ANGLES OF PREVAILING CURRENTS. TO BE EFFECTIVE, BARRIERS MUST BE AT INTERVALS OF APPROX. 15 TIMES THEIR HEIGHT.
- 7. CALCIUM CHLORIDE APPLICATION APPLY AS NEEDED TO KEEP SURFACE MOIST.

PREMANENT METHODS

- 1. PERMANENT VEGETATION (SEE Ds3)
- 2. TOPSOILING COVER WITH LESS EROSIVE TOPSOIL
- 3. STONE COVER AREAS SUBJECT TO WIND EROSION AND HIGH TRAFFIC AREAS WITH CRUSHED STONE OR COARSE GRAVEL.

MULCHING FOR TEMPORARY STABILIZATION WITHOUT VEGETATION

WHEN MULCH IS USED WITHOUT SEEDING, MULCH SHALL BE APPLIED TO PROVIDE FULL COVERAGE OF THE EXPOSED AREA.

SITE PREPARATION

- 1. GRADE TO PERMIT THE USE OF EQUIPMENT FOR APPLYING AND ANCHORING MULCH.
- 2. INSTALL NEEDED EROSION CONTROL MEASURES AS REQUIRED SUCH AS DIKES, DIVERSIONS, BERMS, TERRACES AND SEDIMENT BARRIERS.
- 3. LOOSEN COMPACT SOIL TO A MINIMUM DEPTH OF 3 INCHES.

APPLICATION

- 1. DRY STRAW OR HAY MULCH AND WOOD CHIPS SHALL BE APPLIED UNIFORMLY BY HAND OR BY MECHANICAL EQUIPMENT.
- 2. IF THE AREA WILL EVENTUALLY BE COVERED WITH PERENNIAL VEGETATION, ADD 20-30 POUNDS OF NITROGEN PER ACRE IN ADDITION TO THE NORMAL AMOUNT.

ANCHORING MULCH

- 1. STRAW OR HAY MULCH CAN BE PRESSED INTO THE SOIL WITH A DISK HARROW WITH THE DISK SET STRAIGHT OR WITH A SPECIAL "PACKER DISK." DISKS MAY BE SMOOTH OR SERRATED AND SHOULD BE 20 INCHES OR MORE IN DIAMETER AND 8 TO 12 INCHES APART. THE EDGES OF THE DISK SHOULD BE DULL ENOUGH NOT TO CUT THE MULCH BUT TO PRESS IT INTO THE SOIL LEAVING MUCH OF IT IN AN ERECT POSITION. STRAW OR HAY MULCH SHALL BE ANCHORED IMMEDIATELY AFTER APPLICATION.
- 2 STRAW OR HAY MUI CH SPREAD WITH SPECIAL BLOWER-TYPE FOUIPMENT MAY BE ANCHORED WITH EMULSIFIED ASPHALT (GRADE AE-5 OR SS-1. THE ASPHALT EMULSION SHALL BE SPRAYED ONTO THE MULCH AS IT IS EJECTED FROM THE MACHINE. USE 100 GALLONS OF EMULSIFIED ASPHALT AND 100 GALLONS OF WATER PER TON OF MULCH, TACKIFERS AND BINDERS CAN BE SUBSTITUTED FOR EMULSIFIED ASPHALT. PLEASE REFER TO SPECIFICATION TB -TACKIFERS AND BINDERS. PLASTIC MESH OR NETTING WITH MESH NO LARGER THAN ONE INCH BY ONE INCH SHALL BE INSTALLED ACCORDING TO MANUFACTURER'S SPECIFICATIONS.
- 3. NETTING OF THE APPROPRIATE SIZE SHALL BE USED TO ANCHOR WOOD WASTE. OPENINGS OF THE NETTING SHALL NOT BE LARGER THAN THE AVERAGE SIZE OF THE WOOD WASTE CHIPS.
- 4. POLYETHYLENE FILM SHALL BE ANCHOR TRENCHED AT THE TOP AS WELL AS INCREMENTALLY AS NECESSARY.

MULCH MATERIALS AND APPLICATION RATES	
MATERIAL	RATE
STRAW OR HAY	2-4" DEEP
WOOD WASTE, CHIPS, SAW DUST, OR BARK	2-3" DEEP (ABOUT 6-9 TONS/ACRE)
MATTING OR NETTING	ACCORDING TO MANUFACTURER RECOMMENDATIONS
POLYETHYLENE FILM	CAN BE LAID OVER SENSITIVE AREAS AND STOCKPILES, MUST BE SECURED.

Ds2

DISTURBED AREA STABILIZATION

(WITH TEMPORARY SEEDING)

GRADING AND SHAPING

- EXCESSIVE WATER RUNOFF SHALL BE REDUCED BY PRACTICES SUCH AS CLOSED DRAINS, DITCHES, DIKES, DIVERSIONS, AND OTHERS
- 2. NO SHAPING OR GRADING IS REQUIRED IF SLOPES CAN BE STABILIZED BY HAND-SEEDED VEGETATION OR IF HYDRAULIC SEEDING FOUIPMENT IS TO BE

- 1. WHEN A HYDRAULIC SEEDER IS USED, SEEDBED PREPARATION IS NOT REQUIRED.
 WHEN USING CONVENTIONAL OR HAND—SEEDING, SEEDBED PREPARATION IS NOT REQUIRED IF THE SOIL MATERIAL IS LOOSE AND NOT SEALED BY RAINFALL.

 2. WHEN SOIL HAS BEEN SEALED BY RAINFALL OR CONSISTS OF SMOOTH CUT
- SLOPES, THE SOIL SHALL BE PITTED, TRENCHED OR OTHERWISE SCARIFIED TO PROVIDE A PLACE FOR SEED TO LODGE AND GERMINATE.

LIME AND FERTILIZER

- SOIL TESTS MUST BE PERFORMED DETERMINE THE REQUIRED AMOUNTS OF FERTILIZER, LIME, AND OTHER AMENDMENTS. SOIL TESTS SHOULD INCLUDE RECOMMENDATIONS FOR APPLICATION RATES.

 2. APPLY AGRICULTURAL LIME AT A RATE DETERMINED BY SOIL TEST FOR PH. QUICK
- ACTING LIME SHOULD BE INCORPORATED TO MODIFY PH DURING THE GERMINATION
- 3. ALL GRADED AREAS REQUIRE LIME APPLICATION UNLESS SOIL TEST INDICATE OTHERWISE
- 4. BIOSTIMULANTS SHOULD ALSO BE CONSIDERED WHEN THERE IS LESS THAN 3% ORGANIC MATTER IN THE SOIL.

 5. FERTILIZER SHOULD BE APPLIED BEFORE SEEDBED PREPARATION AND
- INCORPORATED WITH A DISK, RIPPER, OR CHISEL. ON SLOPES TOO STEEP FOR, OR INACCESSIBLE TO EQUIPMENT, FERTILIZER SHALL BE HYDRAULICALLY APPLIED, PREFERABLY IN THE FIRST PASS WITH SEED AND SOME HYDRAULIC MULCH, THEN TOPPED WITH THE REMAINING REQUIRED APPLICATION RATE.
- 6. FOR LOW FERTILITY SOILS, AGRICULTURAL LIME & FERTILIZER REQUIRED UNLESS SOIL TESTS SHOW IT IS NOT REQUIRED AND THAT SOILS ARE REASONABLY FERTILE. FOR LOW FERTILITY SOILS, APPLY 10-10-10 FERTILIZER AT 500-700 LB/ACRE. APPLY AGRICULTURAL LIME AT 1 TON PER ACRE.

SEEDING
SELECT A GRASS OR GRASS-LEGUME MIXTURE SUITABLE TO THE AREA AND SEASON OF THE YEAR. SEED SHALL BE APPLIED UNIFORMLY BY HAND, CYCLONE SEEDER, FERTILIZER). DRILL OR CULTIPACKER-SEEDERS SHOULD NORMALLY PLACE SEED ONE-QUARTER TO ONE-HALF INCH DEEP. APPROPRIATE DEPTH OF PLANTING IS TEN TIMES THE SEED DIAMETER. SOIL SHOULD BE "RAKED" LIGHTLY TO COVER SEED WITH SOIL IF SEEDED BY HAND.

MULCHING
TEMPORARY VEGETATION CAN, IN MOST CASES, BE ESTABLISHED WITHOUT THE USE OF MULCH, PROVIDED THERE IS LITTLE TO NO EROSION POTENTIAL. HOWEVER, THE USE OF MULCH CAN OFTEN ACCELERATE AND ENHANCE GERMINATION AND VEGETATION ESTABLISHMENT. MULCH WITHOUT SEEDING SHOULD BE CONSIDERED FOR SHORT TERM PROTECTION. REFER TO DS1 - DISTURBED AREA STABILIZATION (Ds1).

JATION
DURING TIMES OF DROUGHT, WATER SHALL BE APPLIED AT A RATE NOT CAUSING
RUNOFF AND EROSION. THE SOIL SHALL BE THOROUGHLY WETTED TO A DEPTH THAT
WILL INSURE GERMINATION OF THE SEED. SUBSEQUENT APPLICATIONS SHOULD BE

DISTURBED AREA STABILIZATION (WITH TEMPORARY SEEDING)

TEIMI GIVIKT SEEDING)								
SPECIES		SEEDING SEEDING RATE PER RATE PER		PLANTING DATES				
		1,000 S.F.	RATE PER ACRE*	MTNS./ LIMESTONE	PIEDMONT	COASTAL		
BARLEY	(ALONE) (IN MIXTURE)	3.3 LBS. 0.6 LBS.	3 bu. 1/2 bu.	9/1-10/31	9/15–11/15	10/1-12/31		
RYE	(ALONE) (IN MIXTURE)	3.9 LBS. 0.6 LBS.	3 bu. 1/2 bu.	8/15-10/31	9/15–11/30	10/1-12/31		
ANNUAL RYEGRASS	ALONE	0.9 LBS.	40 LBS.	8/15–11/15	9/1-12/15	9/15–12/3 [,]		
ANNUAL LESPEDEZA	(ALONE) (IN MIXTURE)	0.9 LBS. 0.2 LBS.	40 LBS. 10 LBS.	3/1–3/31	3/1-3/31	2/1-2/28		
WEEPING LOVEGRASS	(ALONE) (IN MIXTURE)	0.1 LBS. 0.05 LBS.	4 LBS. 2 LBS.	4/1-5/31	4/1-5/31	3/1-5/31		
SUDANGRASS		1.4 LBS.	60 LBS.	5/1-7/31	5/1-7/31	4/1-7/31		
BROWN TOP MILLET	(ALONE) (IN MIXTURE)	0.9 LBS. 0.2 LBS.	40 LBS. 10 LBS.	4/15-6/15	4/15-6/60	4/15-6/30		
WHEAT	(ALONE) (IN MIXTURE)	4.1 LBS. 0.7 LBS.	3 bu. 1/2 bu.	9/15-11/30	10/1-12-15	10/15–12/31		

- UNUSUAL SITE CONDITIONS MAY REQUIRE HEAVIER SEEDING RATES.
- SEEDING DATES MAY NEED TO BE ALTERED TO FIT TEMPERATURE VARIATIONS AND LOCAL CONDITIONS.
- SEE "THE MANUAL FOR EROSION & SEDIMENT CONTROL IN GEORGIA, SIXTH EDITION" FOR MAJOR LAND RESOURCE AREAS
- SEEDING RATES ARE BASED ON PURE LIVE SEED. (PLS)






3740 Davinci Ct. Suite 100

f | 770.368.1944 Peachtree Corners, GA 30092

w | www.fg-inc.net

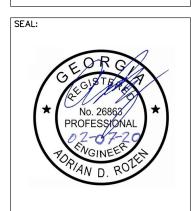

PROJECT:

DATE

TITLE:

HALLWAY 318965

LOCATED AT: 5182 ODUM SMALLWOOD RD GAINESVILLE, GA 30506

APPR	OVALS
CARRIER	
LANDLORD	
LEASING	
CONSTRUCTION	
REVISIONS	DATE
ISSUED FOR:	PERMIT/CONSTRUCTION
PROJECT MANAGER:	MWM
DRAWING BY	A L L

FROSION CONTROL DETAILS

SHEET NUMBER: C - 3.2JOB/FILE NUMBER:

1010.001

02/07/20

DISTURBED AREA STABILIZATION

(WITH PERMANENT VEGETATION)

NOTE THAT IN THE CASE OF DISCREPANCIES BETWEEN ANY OF THE INFORMATION BELOW AND THE INFORMATION CONTAINED IN TREE REPLACEMENT AND LANDSCAPE PLANS & DETAILS, THE LATTER SHALL BE USED.

GRADING AND SHAPING

- 1. GRADING AND SHAPING MAY NOT BE WHERE HYDRAULIC SEEDING AND FERTILIZING EQUIPMENT IS TO BE USED. VERTICAL BANKS SHALL BE SLOPED TO ENABLE PLANT ESTABLISHMENT.
- 2. WHEN CONVENTIONAL SEEDING AND FERTILIZING ARE TO BE DONE, GRADE AND SHAPE WHERE SO THAT EQUIPMENT CAN BE USED SAFELY AND EFFICIENTLY DURING SEEDBED PREPARATION, SEEDING, MULCHING AND MAINTENANCE OF THE VEGETATION.
- 3. CONCENTRATIONS OF WATER THAT WILL CAUSE EXCESSIVE SOIL EROSION SHALL BE DIVERTED TO A SAFE OUTLET. DIVERSIONS AND OTHER TREATMENT PRACTICES SHALL CONFORM WITH THE APPROPRIATE STANDARDS AND SPECIFICATIONS

LIME AND FERTILIZER RATES

- 1. AGRICULTURAL LIME IS REQUIRED AT THE RATE OF ONE TO TWO TONS PER ACRE UNLESS SOIL TESTS INDICATE OTHERWISE. ALL GRADED AREAS REQUIRE LIME APPLICATION UNLESS SOIL TEST INDICATE OTHERWISE. IF LIME IS APPLIED WITHIN SIX MONTHS OF PLANTING PERMANENT PERENNIAL VEGETATION, ADDITIONAL LIME IS NOT REQUIRED. AGRICULTURAL LIME SHALL BE WITHIN THE SPECIFICATIONS OF THE GEORGIA DEPARTMENT OF AGRICULTURE
- 2. AGRICULTURAL LIME IS GENERALLY NOT REQUIRED WHERE ONLY TREES AND SOME LANDSCAPING IS PLANTED. REFER TO TREE PROTECTION AND LANDSCAPE PLANS FOR LIME REQUIREMENTS IN AREAS OF TREES AND SHRUBS.
- 3. REFER TO THE TABLE ON THIS SHEET OR TABLE 6-5.1 OF THE MANUAL FOR EROSION & SEDIMENT CONTROL IN GA, SIXTH EDITION, FOR FERTILIZER REQUIREMENTS BY PLANTING SPECIES.

LIME AND FERTILIZER APPLICATION

- 1. WHEN HYDRAULIC SEEDING EQUIPMENT IS USED, THE INITIAL FERTILIZER SHALL BE MIXED WITH SEED, INNOCULANT (IF NEEDED), AND WOOD CELLULOSE OR WOOD PULP FI BER MULCH AND APPLIED IN A SLURRY. THE INNOCULANT, IF NEEDED, SHALL BE MIXED WITH THE SEED PRIOR TO BEING PLACED INTO THE HYDRAULIC SEEDER. THE SLURRY MIXTURE WILL BE AGITATED DURING APPLICATION TO KEEP THE INGREDIENTS THOROUGHLY MIXED. THE MIXTURE WILL BE SPREAD UNIFORMLY OVER THE AREA WITHIN ONE HOUR AFTER BEING PLACED IN THE HYDROSEEDER.
- 2. FINELY GROUND LIMESTONE CAN BE APPLIED IN THE MULCH SLURRY OR IN COMBINATION WITH THE TOP DRESSING.
- 3. WHEN CONVENTIONAL PLANTING IS TO BE DONE, LIME AND FERTILIZER SHALL BE APPLIED UNIFORMLY IN ONE OF THE FOLLOWING WAYS:
 - a. APPLY BEFORE LAND PREPARATION SO THAT IT WILL BE MIXED WITH THE SOIL DURING SEEDBED PREPARATION.
 - b. MIX WITH THE SOIL USED TO FILL THE HOLES, DISTRIBUTE IN FURROWS. c. BROADCAST AFTER STEEP SURFACES ARE SCARIFIED. PITTED OR TRENCHED.
 - d. A FERTILIZER PELLET SHALL BE PLACED AT ROOT DEPTH IN THE CLOSING HOLE BESIDE EACH PINE TREE SEEDLING.

1. PLANT AND LANDSCAPE SPECIES TO BE AS INDICATED ON THE TREE REPLACEMENT PLAN AND LANDSCAPE PLANS. IN THE EVENT NO SUCH PLAN HAS BEEN PREPARED, AND SPECIES IS NOT CALLED OUT SPECIFICALLY ON THE PERMANENT VEGETATION PLAN, SPECIES ARE TO BE SELECTED BASED ON THE TABLES SHOWN ON THIS SHEET OR FROM TABLES 6-4.1, 6-5.2, 6-5.3, OR 6.5-4 OF THE MANUAL FOR EROSION & SEDIMENT CONTROL IN GEORGIA, SIXTH EDITION, AND APPROVED IN

RYEGRASS SHALL NOT BE USED IN ANY SEEDING MIXTURES CONTAINING PERENNIAL SPECIES DUE TO ITS ABILITY TO OUT-COMPETE DESIRED SPECIES CHOSEN FOR PERMANENT PERENNIAL COVER.

SEEDBED PREPARATION

SEEDBED PREPARATION MAY NOT BE REQUIRED WHERE HYDRAULIC SEEDING AND FERTILIZING EQUIPMENT IS TO BE USED (BUT IS STRONGLY RECOMMENDED FOR ANY SEEDING PROCESS, WHEN POSSIBLE). WHEN CONVENTIONAL SEEDING IS TO BE USED, SEEDBED PREPARATION WILL BE DONE AS FOLLOWS:

BROADCAST PLANTINGS

- 1. TILLAGE, AT A MINIMUM, SHALL ADEQUATELY LOOSEN THE SOIL TO A DEPTH OF 4 TO 6 INCHES; ALLEVIATE COMPACTION; INCORPORATE LIME AND FERTILIZER; SMOOTH AND FI RM THE SOIL; ALLOW FOR THE PROPER PLACEMENT OF SEED, SPRIGS, OR PLANTS; AND ALLOW FOR THE ANCHORING OF STRAW OR HAY MULCH IF A DISK IS TO BE USED
- 2. TILLAGE MAY BE DONE WITH ANY SUITABLE EQUIPMENT.
- 3. TILLAGE SHOULD BE DONE ON THE CONTOUR WHERE FEASIBLE.
- 4. ON SLOPES TOO STEEP FOR THE SAFE OPERATION OF TILLAGE EQUIPMENT, THE SOIL SURFACE SHALL BE PITTED OR TRENCHED ACROSS THE SLOPE WITH APPROPRIATE HAND TOOLS TO PROVIDE TWO PLACES 6 TO 8 INCHES APART IN WHICH SEED MAY LODGE AND GERMINATE. HYDRAULIC SEEDING MAY ALSO BE USED.

INDIVIDUAL PLANTS

1. ALL INDIVIDUAL PLANTINGS SHOULD BE PERFORMED IN ACCORDANCE WITH LANDSCAPE OR TREE REPLACEMENT PLANS.

INOCULANTS

- 1. ALL LEGUME SEED SHALL BE INOCULATED WITH APPROPRIATE NITROGEN-FIXING BACTERIA. THE INOCULANT SHALL BE A PURE CULTURE PREPARED SPECIFICALLY FOR THE SEED SPECIES AND USED WITHIN THE DATES ON THE CONTAINER
- 2. A MIXING MEDIUM RECOMMENDED BY THE MANUFACTURER SHALL BE USED TO BOND THE INOCULANT TO THE SEED. FOR CONVENTIONAL SEEDING, USE TWICE THE AMOUNT OF INOCULANT RECOMMENDED BY THE MANUFACTURER. FOR HYDRAULIC SEEDING, FOUR TIMES THE AMOUNT OF INOCULANT RECOMMENDED BY THE MANUFACTURER SHALL BE USED.
- 3. ALL INOCULATED SEED SHALL BE PROTECTED FROM THE SUN AND HIGH TEMPERATURES AND SHALL BE PLANTED THE SAME DAY INOCULATED. NO INOCULATED SEED SHALL REMAIN IN THE HYDROSEEDER LONGER THAN ONE HOUR

PLANTING

HYDRAULIC SEEDING

MIX THE SEED (INOCULATED IF NEEDED), FERTILIZER, AND WOOD CELLULOSE OR WOOD PULP FIBER MULCH WITH WATER AND APPLY IN A SLURRY UNIFORMLY OVER THE AREA TO BE TREATED. APPLY WITHIN ONE HOUR AFTER THE MIXTURE IS MADE.

CONVENTIONAL SEEDING

SEEDING WILL BE DONE ON A FRESHLY PREPARED AND FIRMED SEEDBED. FOR BROADCAST PLANTING, USE A CULTIPACKER-SEEDER, DRILL, ROTARY SEEDER, OTHER MECHANICAL SEEDER, OR HAND SEEDING TO DISTRIBUTE THE SEED UNIFORMLY OVER THE AREA TO BE TREATED. COVER THE SEED LIGHTLY WITH 1/8 TO 1/4 INCH OF SOIL FOR SMALL SEED AND 1/2 TO 1 INCH FOR LARGE SEED WHEN USING A CULTIPACKER OR OTHER SUITABLE EQUIPMENT.

NO-TILL SEEDING

NO-TILL SEEDING IS PERMISSIBLE INTO ANNUAL COVER CROPS WHEN PLANTING IS DONE FOLLOWING MATURITY OF THE COVER CROP OR IF THE TEMPORARY COVER STAND IS SPARSE ENOUGH TO ALLOW ADEQUATE GROWTH OF THE PERMANENT (PERENNIAL) SPECIES. NO-TILL SEEDING SHALL BE DONE WITH APPROPRIATE NO-TILL SEEDING EQUIPMENT. THE SEED MUST BE UNIFORMLY DISTRIBUTED AND PLANTED AT THE PROPER DEPTH.

MULCHING

MULCH IS REQUIRED FOR ALL PERMANENT VEGETATION APPLICATIONS, MULCH APPLIED TO SEEDED AREAS SHALL ACHIEVE 75% TO 100% SOIL COVER PERMANENT MULCH COVER SELECTION WHERE VEGETATION IS NOT APPLIED SHOULD BE PLACED AS INDICATED ON TREE REPLACEMENT AND/OR LANDSCAPING PLANS. OR AT THE DIRECTION OR APPROVAL OF THE OWNER, MULCH SELECTION FOR TEMPORARY COVER OF PERMANENT VEGETATION SHALL BE BASED ON SELECTION GUIDELINES IN THE "MULCH REQUIREMENTS FOR PERMANENT STABILIZATION" TABLE ON THIS SHEET.

WOOD CELLULOSE AND WOOD PULP FIBERS SHALL NOT CONTAIN GERMINATION OR GROWTH INHIBITING FACTORS. THEY SHALL BE EVENLY DISPERSED WHEN AGITATED IN WATER. THE FI BERS SHALL CONTAIN A DYE TO ALLOW VISUAL METERING AND AID IN UNIFORM APPLICATION DURING SEEDING. APPLYING MULCH

APPLYING MULCH

STRAW OR HAY MULCH WILL BE SPREAD UNIFORMLY WITHIN 24 HOURS AFTER SEEDING AND/OR PLANTING. THE MULCH MAY BE SPREAD BY BLOWER-TYPE SPREADING EQUIPMENT, OTHER SPREADING EQUIPMENT OR BY HAND. MULCH SHALL BE APPLIED TO COVER 75% OF THE SOIL SURFACE..

WOOD CELLULOSE OR WOOD FIBER MULCH SHALL BE APPLIED UNIFORMLY WITH HYDRAULIC SEEDING EQUIPMENT.

ANCHORING MULCH

ANCHOR STRAW OR HAY MULCH IMMEDIATELY AFTER APPLICATION BY ONE OF THE FOLLOWING METHODS:

- 1. HAY AND STRAW MULCH SHALL BE PRESSED INTO THE SOIL IMMEDIATELY AFTER THE MULCH IS SPREAD. A SPECIAL "PACKER DISK" OR DISK HARROW WITH THE DISKS SET STRAIGHT MAY BE USED. THE DISKS MAY BE SMOOTH OR SERRATED AND SHOULD BE 20 INCHES OR MORE IN DIAMETER AND 8 TO 12 INCHES APART, THE FDGES OF THE DISKS SHALL BE DULL ENOUGH TO PRESS THE MULCH INTO THE GROUND WITHOUT CUTTING IT, LEAVING MUCH OF IT IN AN ERECT POSITION. MULCH SHALL NOT BE PLOWED INTO THE SOIL.
- 2. SYNTHETIC TACKIFIERS, BINDERS OR HYDRAULIC MULCH SPECIFICALLY DESIGNED TO TACK STRAW, SHALL BE APPLIED IN CONJUNCTION WITH OR IMMEDIATELY AFTER THE MULCH IS SPREAD. SYNTHETIC TACKIFIERS SHALL BE MIXED AND APPLIED ACCORDING TO MANUFACTURER'S SPECIFICATIONS, ALL TACKIFIERS, BINDERS, OR HYDRAULIC MULCH SPECIFICALLY DESIGNED TO TACK STRAW SHOULD BE VERIFIED NONTOXIC THROUGH EPA 2021.0 TESTING, REFER TO TACKIFIERS-TAC.
- 3. RYE OR WHEAT CAN BE INCLUDED WITH FALL AND WINTER PLANTINGS TO STABILIZE THE MULCH. THEY SHALL BE APPLIED AT A RATE OF ONE-QUARTER TO ONE-HALF BUSHEL PER ACRE.
- 4. PLASTIC MESH OR NETTING WITH MESH NO LARGER THAN ONE INCH BY ONE INCH MAY BE NEEDED TO ANCHOR STRAW OR HAY MUICH ON UNSTABLE SOILS AND CONCENTRATED FLOW AREAS. THESE MATERIALS SHALL BE INSTALLED AND ANCHORED ACCORDING TO MANUFACTURER'S SPECIFICATIONS.

BEDDING MATERIAL

MULCH SHALL BE APPLIED TO ORNAMENTAL BEDS, AROUND SHRUBS, AND ON BARE AREAS ON LAWNS. WHEN BEDDING MATERIALS ARE NOT SPECIFIED ON THE LANDSCAPE AND/OR TREE REPLACEMENT PLANS, THE CONTRACTOR SHALL SELECT AND SEEK PRIOR APPROVAL OF THE OWNER TO PLACE BEDDING MATERIAL SHOWN IN THE "MULCH REQUIREMENTS FOR PERMANENT STABILIZATION" TABLE ON THIS SHEET.

WATER SHALL BE APPLIED AT A RATE NOT CAUSING RUNOFF AND FROSION

TOPDRESSING

TOPDRESSING WILL BE APPLIED ON ALL TEMPORARY AND PERMANENT (PERENNIAL) SPECIES PLANTED ALONE OR IN MIXTURES WITH OTHER SPECIES, RECOMMENDED RATES OF APPLICATION ARE LISTED ON THIS. SHEET AND IN TABLE 6-5.1. OF THE MANUAL FOR EROSION AND SEDIMENT CONTROL IN GA, SIXTH EDITION.

verizon



3740 Davinci Ct. Suite 100

f | 770.368.1944 Peachtree Corners, GA 30092



PROJECT:

HALLWAY 318965

LOCATED AT: 5182 ODUM SMALLWOOD RD GAINESVILLE, GA 30506

APPR	ROVALS
CARRIER	
LANDLORD	
LEASING	
CONSTRUCTION	
REVISIONS	DATE
ISSUED FOR:	PERMIT/CONSTRUCTION
PROJECT MANAGER:	MWM
DRAWING BY:	ALK

	EROSION
CONTROL	DETAILS

02/07/20

SHEET NUMBER C - 3.3JOB/FILE NUMBER: 1010.001

DATE

TITLE:

SEE TABLES ON SHEET C-3.4

PLA	nting and	FERTILIZ	ZER SCHEDUL	E FOR P	ERMANEN	T GRASSIN	G					
SPECIES	PURE LIVE SEED	LIVE SEED RAIL (PLS) PER PER		ANTING DATES		YEARS TO APPLY	FERTILIZEF ANALYSIS			FERTILIZER RATE	N TOP DRESSING	
	1,000 S.F.	ACRE	MTNS./ LIMESTONE	PIEDMONT	COASTAL	FERTILIZER	N	Р	K	(lb/Ac) RATE	RATE	
WEEPING LOVEGRASS AND	0.1 LBS.	4 LBS.	3/15 - 6/15	3/1 - 6/15	2/1 - 6/15	FIRST	6	12	12	1500	50	
VIRGATA OR SERICEA LESPEDEZA	1.4 LBS.	40 LBS.	3/15 - 6/15	3/1 - 6/15	2/15 - 6/1	SECOND	0	10	10	1000	-	
SERICEA LESPEDEZA SEEDBEARING HAY WITH	138 LBS.	3 TONS	10/1 - 3/1	10/1 - 3/1	10/15 - 2/1	FIRST	6	12	12	1500	50	
OVERSEEDED WEEPING LOVEGRASS	0.05 LBS.	2 LBS.	3/1 - 6/15	3/1 - 6/15	2/1 - 6/15	SECOND	0	10	10	1000	Ì	
HULLED COMMON BERMUDAGRASS AND	0.2 LBS.	10 LBS.	N/A	2/15 - 7/1	2/15 - 6/15	FIRST	6	12	12	1500	50	
SERICEA LESPEDEZA	1.4 LBS.	60 LBS.	N/A	3/1 - 6/15		SECOND	0	10	10	1000	İ	
UNHULLED COMMON BERMUDAGRASS	0.2 LBS.	10 LBS.	N/A	11/1 – 2/1	2/15 – 6/15	FIRST	6	12	12	1500	50	
AND VIRGATA OR	1.4 LBS.	40 LBS.	N/A	3/1 - 6/15	SECOND	15 SECOND	SECOND	0	10	10	1000	_
SERICEA LESPEDEZA SEED HAY	140 LBS.	3 TONS	N/A	10/1 – 3/1		SECOND		10	10	1000	-	
TALL FESCUEGRASS	0.7 LBS	30 LBS	8/1 - 11/1	8/15 – 11/1	0.45	FIRST	6	12	12	1500	50(1)	
AND CLEAN COMBINE RUN VIRGATA OR SERICEA LESPEDEZA	1.4 LBS.	40 LBS.	3/1-4/15 (3/15-5/1 FOR LESPEDEZA)	3/1 - 6/15	2/15 – 6/1	SECOND	0	10	10	1000	_	
TALL FESCUEGRASS (ALONE)	1.1 LBS	50LBS	3/1-5/1, 8/15-11/1	9/1-11/1	N /A	FIRST	6	12	12	1500	0-50(1),(2)	
FESTUCA ARUNDINÀCEA	1.1 LB3	30LB3	3/1-3/1, 0/13-11/1		SECOND	6	12	12	1000	ı		
COMMON BERMUDA, HULLED ALONE	0.2 LBS.	10 LBS.	N/A	4/1-4/31	3/15-5/31	FIRST	6	12	12	1500	50-100	
CYNODON DACTYLON	U.Z LB3.	IU LDS.	N/A	4/1-4/51	3/15-5/31	SECOND	6	12	12	800	50-100	
COMMON BERMUDA, UNHULLED	0.2 LBS.	10 LBS.	N/A	10 /1 – 3 /1	10/1-3/1 11/1-2/1	FIRST	6	12	12	1500	50-100	
CYNODON DACTYLON (PLANT WITH WINTER ANNUALS)	0.2 LB3.	10 LB3.	"/^	10/1-3/1		SECOND	6	12	12	800	50-100	

1 — APPLY IN SPRING FOLLOWING SEEDING 2 — APPLY IN SPLIT APPLICATIONS WHEN HIGH RATES ARE USED 3 — APPLY IN 3 SPLIT APPLICATIONS

4	_	APPLY	WHEN	PLANTS	ARE	PRUNED


5 - APPLY TO GRASS SPECIES ONLY 6 - APPLY WHEN PLANTS GROW TO A HEIGHT OF 2-4 INCHES.

MULCH REQUIREM	MENTS FOR F	PERMANENT STABILIZATION		
MATERIAL	RATE	WHERE TO USE		
DRY STRAW	2 TONS/ACRE	TEMPORARY COVER IN SEEDED AREAS		
DRY HAY	2-1/2 TONS/ACRE			
WOOD CELLULOSE MULCH OR WOOD PULP FIBER	500 LB/ACRE	HYDRAULIC APPLICATIONS (REQUIRES STRAW OR HAY APPLICATION NOTED ABOVE FOLLOWING HYDRAULIC SEEDING)		
WOOD CELLULOSE OR WOOD PULP FIBER W/ TACKIFIER	1,000 LB/ACRE	USE FOR HYDRAULIC SEEDING ON SLOPES 3/4:1 AND GREATER		
SERICEA LESPEDEZA HAY (CONTAINING MATURE SEED)	3 TONS/ACRE	USE ON AREAS WHERE SERICEA LESPEDEZA IS MAY BE ESTABLISHED		
GRAIN STRAW	4" TO 6"			
GRASS HAY	4" TO 6"	FOR AREAS WHERE ORNAMENTALS OR GROUND COVERS ARE PLANTED AND NO LANDSCAPE/TREE		
PINE NEEDLES	3" TO 5"	REPLACEMENT PLANS HAVE BEEN PREPARED THAT SPECIFY OTHERWISE. REQUIRES ADVANCE		
CHIPPED WOOD MULCH	4" TO 6"	APPROVAL OF OWNER. NOT APPROPRIATE FOR GRASS SEEDING APPLICATIONS.		
PINE BARK	4" TO 6"	SIVISS SEESING AIT EIGHTIONS.		





Foresite Group, LLC | W | www.fg-inc.net 3740 Davinci Ct. | o | 770.368.1399 Suite 100 | f | 770.368.1944 Peachtree Corners, GA 30092

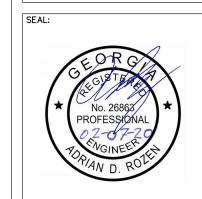

PROJECT:

HALLWAY 318965

LOCATED AT: 5182 ODUM SMALLWOOD RD GAINESVILLE, GA 30506


APPR	OVALS
CARRIER	
LANDLORD	
LEASING	
CONSTRUCTION	
REVISIONS	DATE
ISSUED FOR:	PERMIT/CONSTRUCTION
PROJECT MANAGER:	MWM
DRAWING BY:	ALK
DATE:	02/07/20
TITLE:	

EROSION CONTROL DETAILS

1010.001

JOB/FILE NUMBER:

SHEET NUMBER: C - 3.4

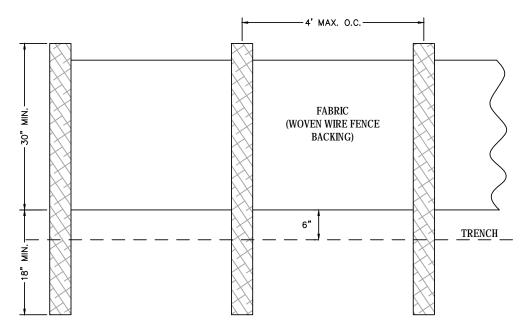


- NOTES:

 1. USE STEEL OR WOOD POSTS OR AS SPECIFIED BY THE EROSION, SEDIMENTATION, AND POLLUTION CONTROL PLAN.


 2. THE EROSION SEDIMENTATION AND POLLUTION CONTROL PLAN.
- 2. HEIGHT (*) IS TO BE SHOWN ON THE EROSION, SEDIMENTATION, AND POLLUTION CONTROL PLAN.

FRONT VIEW

SILT FENCE -TYPE SENSITIVE NOT TO SCALE

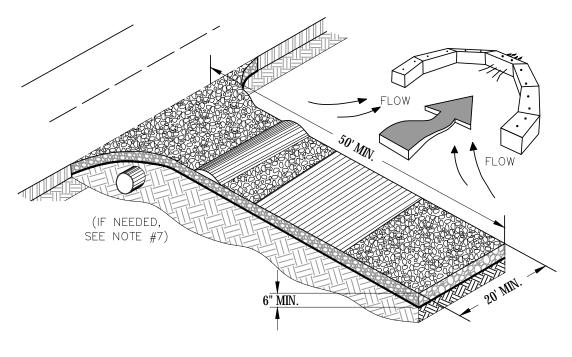



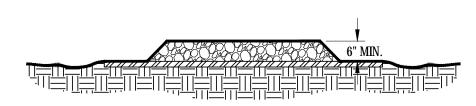

- 1. AVOID LOCATING ON STEEP SLOPES OR AT CURVES ON PUBLIC ROADS.
 2. REMOVE ALL VEGETATION AND OTHER UNSUITABLE MATERIAL FROM THE FOUNDATION AREA, GRADE, AND CROWN FOR POSITIVE DRAINAGE.
- AGGREGATE SIZE SHALL BE IN ACCORDANCE WITH NATIONAL STONE ASSOCIATION R-2 (1.5"-3.5" STONE).
- GRAVEL PAD SHALL HAVE A MINIMUM THICKNESS OF 6".
- PAD WIDTH SHALL BE EQUAL FULL WIDTH AT ALL POINTS OF VEHICULAR EGRESS, BUT NO LESS THAN 20'.

- 6. A DIVERSION RIDGE SHOULD BE CONSTRUCTED WHEN GRADE TOWARD PAVED AREA IS GREATER THAN 2%.
 7. INSTALL PIPE UNDER THE ENTRANCE IF NEEDED TO MAINTAIN DRAINAGE DITCHES.
 8. WHEN WASHING IS REQUIRED, IT SHOULD BE DONE ON AN AREA STABILIZED WITH CRUSHED STONE THAT DRAINS INTO AN APPROVED SEDIMENT TRAP OR SEDIMENT BASIN (DIVERT ALL SURFACE RUNOFF AND DRAINAGE FROM THE ENTRANCE TO A SEDIMENT CONTROL DEVICE).
- 9. WASHRACKS AND/OR TIRE WASHERS MAY BE REQUIRED DEPENDING ON SCALE AND CIRCUMSTANCE. IF NECESSARY, WASHRACK DESIGN MAY CONSIST OF ANY MATERIAL <u>SUITABLE</u> FOR TRUCK TRAFFIC THAT REMOVE MUD AND DIRT.
- 10. MAINTAIN AREA IN A WAY THAT PREVENTS TRACKING AND/OR FLOW OF MUD ONTO PUBLIC RIGHTS-OF-WAYS. THIS MAY REQUIRE TOP DRESSING, REPAIR AND/OR CLEANOUT OF ANY MEASURES USED TO TRAP SEDIMENT.


ENTRANCE ELEVATION

CRUSHED STONE CONSTRUCTION EXIT





w | www.fg-inc.net o | 770.368.1399 3740 Davinci Ct. Suite 100 f | 770.368.1944 Peachtree Corners, GA 30092

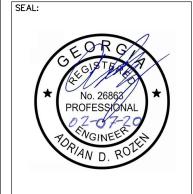

PROJECT:

TITLE:

HALLWAY 318965


LOCATED AT: 5182 ODUM SMALLWOOD RD GAINESVILLE, GA 30506

	·
APPR	OVALS
CARRIER	
LANDLORD	_
LEASING	
CONSTRUCTION	
REVISIONS	DATE
ISSUED FOR:	PERMIT/CONSTRUCTION
PROJECT MANAGER:	MWM
DRAWING BY:	ALK
DATE:	02/07/20

EROSION CONTROL DETAILS

SHEET NUMBER: C - 3.5JOB/FILE NUMBER: 1010.001

UTILITY & STORM PIPE CROSSING DETAIL NOT TO SCALE

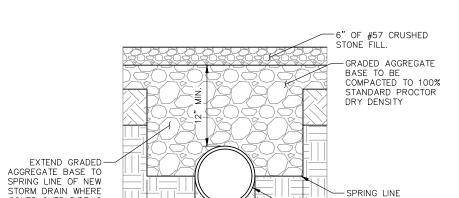

DIAMETER

OF PIPE

-STORM PIPE


COVER OVER PIPE IS

LESS THAN 2.5'

TYPICAL PIPE COVER DETAIL

NOT TO SCALE

UPSTREAM TERMINAL

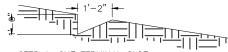

STEP 1: CUT TERMINAL SLOT.




STEP 2: SNUG MAT INTO SLOT.



B. USE 1" X 3" PRESSURE TREATED BOARD TO SPACE MAT AGAINST VERTICAL CUT.


C. BACKFILL AND COMPACT.

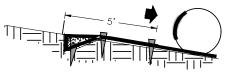


STEP 4: A. REVERSE MAT ROLL DIRECTION TO OVERLAY CHECK LOT.

B. STAKE MAT TO ANCHOR TERMINAL.

TRANSVERSE CHECK SLOT

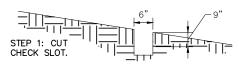


TEMPORARILY STAKE MAT UNDER MODERATE

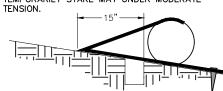

STEP 2: WORK UPSTREAM ACROSS CHECK SLOT AND LAP




STEP 3: TUCK MAT LAP INTO SLOT AND STAKE.

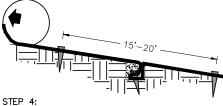

A. BACKFILL AND PROGRESS UPSTREAM

B. PULL OUT TEMPORARY STAKES WHEN NO LONGER NEEDED FOR TENSIONING.


DOWNSTREAM TERMINAL

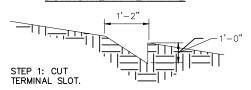



STEP 2: STAKE MAT INTO SLOT.



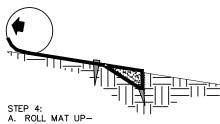


STREAM OVER REFILLED

B. STAKE MAT DOWN TO ANCHOR TERMINAL.

C. PROGRESS UPSTREAM WITH ROLL.



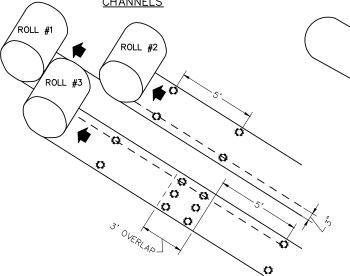

NOTES:

1. START AT DOWNSTREAM TERMINAL AND PROGRESS UPSTREAM.

2. FIRST ROLL IS CENTERED LONGITUDINALLY IN MID—CHANNEL AND PINNED WITH TEMPORARY STAKES TO MAINTAIN ALIGNMENT.

SUBSEQUENT ROLLS FOLLOW IN STAGGERED SEQUENCE BEHIND THE FIRST ROLL. USE THE CENTER ROLL FOR ALIGNMENT TO THE CHANNEL

WORK OUTWARDS FROM THE CHANNEL CENTER TO THE EDGE. USE 3" OVERLAPS AND STAKE AT 5' INTERVALS ALONG THE SEAMS.

6. USE 3' OVERLAPS AND SHINGLE DOWNSTREAM TO CONNECT THE LINING

SLOPE STABILIZATION

NOT TO SCALE



w | www.fg-inc.net o | 770.368.1399 Foresite Group, LLC 3740 Davinci Ct. Suite 100 f | 770.368.1944 Peachtree Corners, GA 30092

SEAL: No. 26863 PROFESSIONAL

PROJECT:

HALLWAY 318965

LOCATED AT: 5182 ODUM SMALLWOOD RD GAINESVILLE, GA 30506

AF	PPROVALS
CARRIER	
LANDLORD	
LEASING	
CONSTRUCTION _	
REVISIONS	DATE
SSUED FOR:	PERMIT/CONSTRUCTION

PROJECT MANAGER: MWM DRAWING BY: ALK DATE: 02/07/20 TITLE:

> **EROSION** CONTROL DETAILS

SHEET NUMBER: C - 3.6JOB/FILE NUMBER: 1010.001

Ss



 $\underline{\text{NOTES:}}$ 1. La is the length of the Riprap apron.


6. FILTER STONE NO. FS-2


2. D= 1.5 TIMES THE MAXIMUM STONE DIAMETER BUT NOT LESS THAN 6".


3. IN A WELL-DEFINED CHANNEL EXTEND THE APRON UP THE CHANNEL BANKS TO AN ELEVATION OF 6" ABOVE THE TOP OF PIPE OR TO THE TOP OF THE BANK, WHICHEVER IS LESS.

4. A FILTER BLANKET OR FILTER FABRIC SHELL BE INSTALLED BETWEEN THE RIPRAP AND SOIL FOUNDATION.
 5. GRADED RIPRAP STONE (MIN. 50 LB. STONE) NSA. NO. R-4 - 12" mix. 6" ave

7. SEE PLANS FOR DIMENSIONS OF EACH INDIVIDUAL OUT PROTECTION RIP RAP PAD

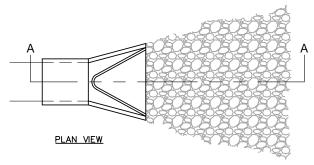

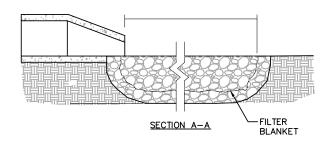

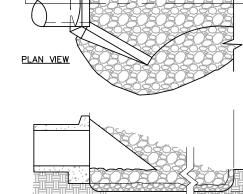

SECTION A-A

St STORM OUTLET PROTECTION NOT TO SCALE





Foresite Group, LLC | w | www.fg-inc.net 3740 Davinci Ct. | o | 770.368.1399 Suite 100 | f | 770.368.1944 Peachtree Corners, GA 30092

SEAL:

REPROPERSIONAL

No. 26863

PROFESSIONAL

POPIAN D. ROLE

ROLE

POPIAN D. ROLE

POPIAN D. ROLE

POPIAN D. ROLE

POPIAN D. ROLE

ROLE

ROLE

ROL

PROJECT:

HALLWAY 318965

LOCATED AT: 5182 ODUM SMALLWOOD RD GAINESVILLE. GA 30506

GAINESVILL	E, GA 30506
APPR	OVALS
CARRIER	
LANDLORD	_
LEASING	
CONSTRUCTION	
REVISIONS	DATE
ISSUED FOR:	PERMIT/CONSTRUCTION
PROJECT MANAGER:	MWM
DRAWING BY:	ALK
DATE:	02/07/20
TITLE:	

EROSION CONTROL DETAILS

SHEET NUMBER: C-3.7

JOB/FILE NUMBER: 1010.001

PLAN VIEW

PIPE OUTLET TO WELL -

DEFINED CHANNEL

(NOT USED)


(NOT USED)

4 OVP-12 (PROPOSED & FUTURE AS NEEDED)


5 ERICSSON RRH 2212 (STACKED 6x3) (RESERVE SPACE FOR FUTURE GROUND RADIOS)

- 6 ILC CABINET (WITHOUT CAMLOCK IF NEEDED)
- 7 DARK FIBER JUNCTION BOX (RESERVE SPACE FOR CHARLES TELCO CABINET IF NECESSARY
- 8 RESERVED DIPLEXER AREA

NOTE: 1. WHEN EQUIPMENT FRAME IS INSTALLED ADJACENT TO CABINET PAD, INTERCONNECTING CONDUITS SHALL BE INSTALLED AT OR ABOVE GRADE.

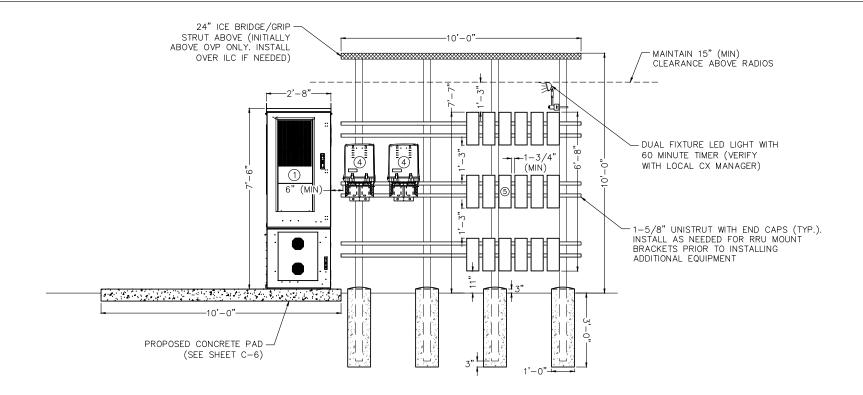


EQUIPMENT ELEVATION - FRONT

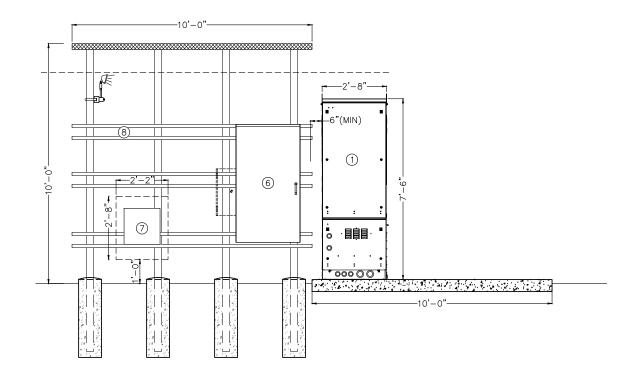

EQUIPMENT ELEVATION - REAR



Foresite Group, LLC 3740 Davinci Ct. Suite 100 w | www.fg-inc.net o | 770.368.1399 f | 770.368.1944 Peachtree Corners, GA 30092

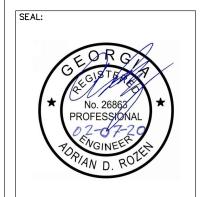

PROJECT:

HALLWAY 318965

LOCATED AT: 5182 ODUM SMALLWOOD RD GAINESVILLE, GA 30506

APPROVALS	
CARRIER	
LANDLORD	
LEASING	
CONSTRUCTION	
REVISIONS DATE	
SSUED FOR: PERMIT/CONSTRUCTION	


PROJECT MANAGER: DRAWING BY: ALK 02/07/20 DATE: TITLE:


EQUIPMENT DETAILS

SHEET NUMBER: C-4JOB/FILE NUMBER: 1010.001

TOWER NOTES:

- 1. THE PROPOSED TOWER, FOUNDATION, ANTENNA MOUNTS, AND ANTENNAS WERE DESIGNED BY OTHERS.
- 2. THE TOWER ELEVATION SHOWN IS FOR REFERENCE ONLY.
- 3. CONTRACTOR TO REFER TO FINAL TOWER DRAWINGS FOR DETAILS ON REQUIRED ANTENNA MOUNTING LAYOUT, COAX ROUTING AND ANY OTHER MODIFICATIONS THAT COULD AFFECT THE OVERALL TOWER STRUCTURAL CAPACITY.
- 4. CONTRACTOR TO FIELD VERIFY ANTENNA MOUNT CONFIGURATION AND PROVIDE MOUNTS OR ADDITIONAL HARDWARE IF REQUIRED TO SUPPORT PROPOSED ANTENNAS. ALL ANTENNAS AND MOUNTING HARDWARE SHALL CONFORM TO DESIGN REQUIREMENTS PER STATE BUILDING CODE & TIA/EIA STRUCTURAL STANDARDS FOR STEEL ANTENNA TOWERS ANTENNA SUPPORTING STRUCTURES AND BASIC WIND SPEED AS LISTED ON SHEET T-1.
- 5. RF INFORMATION SHOWN ON THESE PLANS IS BASED ON LATEST RFDS PROVIDED BY VERIZON WIRELESS. CONTRACTOR TO OBTAIN RFDS FROM VERIZON WIRELESS AT TIME OF CONSTRUCTION FOR FINAL DESIGN AND ADVISE ENGINEER OF DEVIATIONS (IF ANY).
- 6. CENTERLINE OF THE ANTENNAS TO BE WITHIN 6" (VERTICALLY)
 OF THE CENTERLINE OF EACH SECTOR MOUNT, UNLESS SPECIFIED BY ENGINEER.

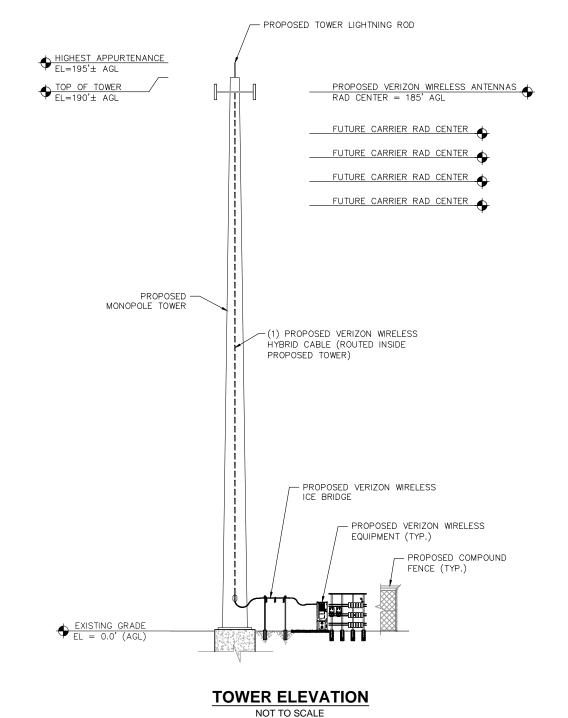

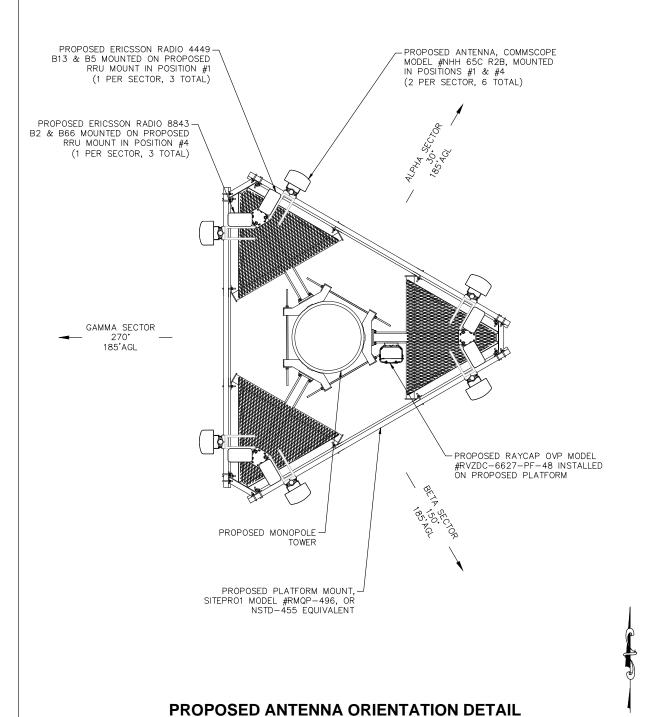


NOT TO SCALE

GENERAL CONTRACTOR TO VERIFY ALL AZIMUTHS WITH MOST UP TO DATE RFDS.



Foresite Group, LLC 3740 Davinci Ct. Suite 100

w | www.fg-inc.net o | 770.368.1399 f | 770.368.1944 Peachtree Corners, GA 30092

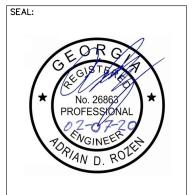

PROJECT:

TITLE:


HALLWAY 318965

LOCATED AT: 5182 ODUM SMALLWOOD RD GAINESVILLE, GA 30506


APPR	OVALS
CARRIER	
LANDLORD	
LEASING	
CONSTRUCTION	
REVISIONS	DATE
ISSUED FOR:	PERMIT/CONSTRUCTION
PROJECT MANAGER:	MWM
DRAWING BY:	ALK
DATE:	02/07/20

TOWER ELEVATION AND ANTENNA ORIENTATION

SHEET NUMBER: C-5JOB/FILE NUMBER: 1010.001 NOTE:
THIS DETAIL FOR REFERENCE
ONLY. CONTRACTOR TO REFER TO
SITE PLAN FOR ACTUAL
ORIENTATION OF EQUIPMENT SLAB.

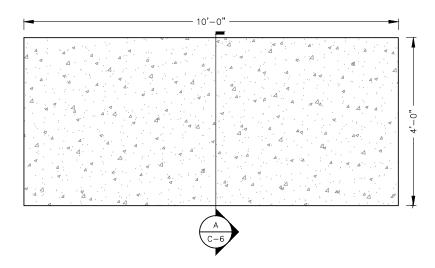


SLAB DETAIL NOT TO SCALE

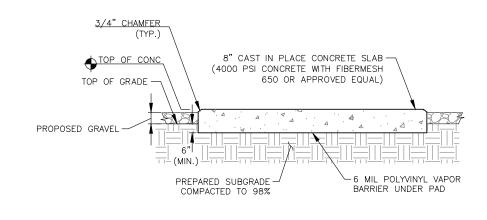


SECTION A

NOT TO SCALE

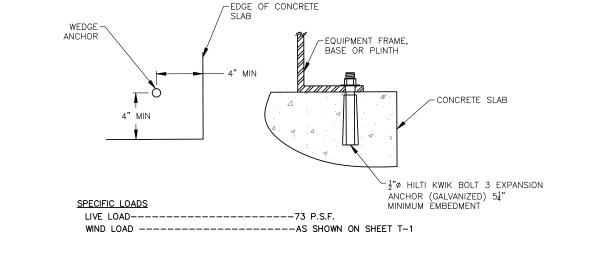


EQUIPMENT ANCHOR BOLT DETAIL

NOT TO SCALE

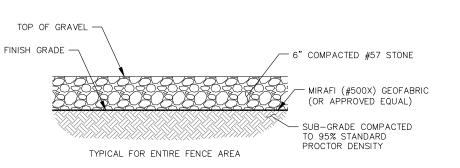

COMPOUND BASE DETAIL

NOT TO SCALE

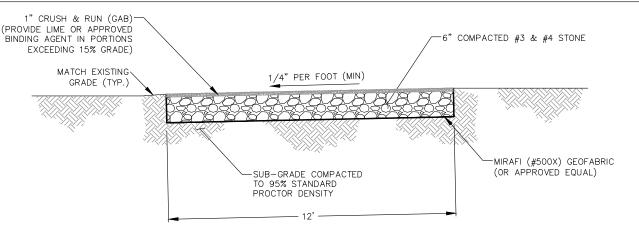

APRON/ACCESS DRIVE DETAIL

NOT TO SCALE





Foresite Group, LLC | W | www.fg-inc.net 3740 Davinci Ct. | o | 770.368.1399 Suite 100 | f | 770.368.1944 Peachtree Corners, GA 30092

SEAL:

PROJECT:

TITLE:


HALLWAY 318965

LOCATED AT: 5182 ODUM SMALLWOOD RD GAINESVILLE, GA 30506

APPROVAL	_S
CARRIER	
LANDLORD	
LEASING	
CONSTRUCTION	
REVISIONS	DATE
ISSUED FOR:	
PROJECT MANAGER:	MWM
DRAWING BY:	ALK
DATE:	02/07/20

FOUNDATION & ACCESS DRIVE DETAILS
SHEET NUMBER:

 $\frac{\text{C}-6}{\text{JOB/FILE NUMBER:}}$

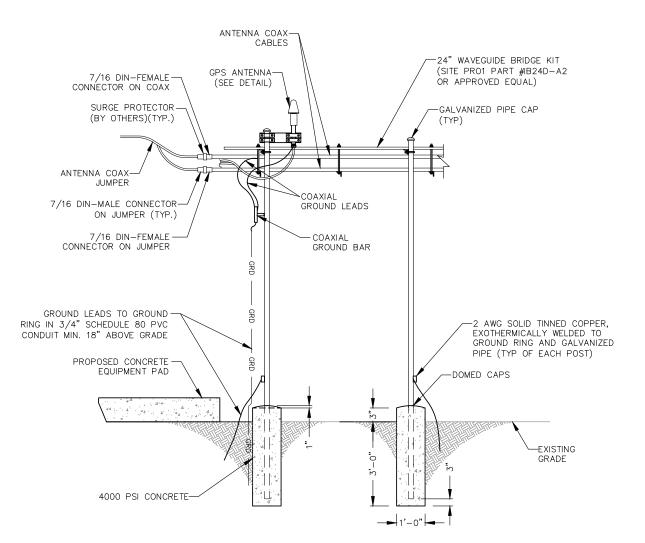

verizon /

FORESITE group

Foresite Group, LLC | W | www.fg-inc.net 3740 Davinci Ct. | 0 | 770.368.1399 Suite 100 | f | 770.368.1944 Peachtree Corners, GA 30092

PROJECT:

DRAWING BY:

DATE: TITLE:

HALLWAY 318965

LOCATED AT: 5182 ODUM SMALLWOOD RD GAINESVILLE, GA 30506

APPROVALS

CARRIER _____

LANDLORD ____

LEASING ____

CONSTRUCTION ____

REVISIONS DATE

ISSUED FOR: PERMIT/CONSTRUCTION PROJECT MANAGER: MWM

ICE BRIDGE DETAILS

02/07/20

 SHEET NUMBER:
 C-7

 JOB/FILE NUMBER:
 1010.001

GPS MOUNTING DETAIL

NOT TO SCALE

ICE BRIDGE ELEVATION


NOT TO SCALE

(INSTALL FENCING PER ASTM F-567, SWING GATES PER ASTM F- 900) 1. GATE POST: 3½" DIA. SCHEDULE 40 PER ASTM-F 1083.

- 2. CORNER AND TERMINAL OR PULL POST: 3" DIA. SCHEDULE 40 PER ASTM-F 1083.
- 3. LINE POST: 2" DIA. SCHEDULE 40 PIPE PER ASTM-F 1083.
- 4. GATE FRAME: 11/2" DIA. SCHEDULE 40 PIPE PER ASTM-F 1083.
- 5. TOP RAIL AND BRACE RAIL: 11/2" DIA. SCHEDULE 40 PIPE PER ASTM-F 1083.
- 6. FABRIC: 9 GA. CORE WIRE SIZE 2" MESH, CONFORMING TO ASTM-A392.
- 7. TIE WIRE: MINIMUM 9 GA. GALVANIZED STEEL AT POSTS AND RAILS A SINGLE WRAP OF FABRIC TIE AND AT TENSION WIRE BY HOG RINGS SPACED MAXIMUM 24" INTERVALS
- 8. TENSION WIRE: 6 GA. GALVANIZED STEEL.
- 9. BARBED WIRE DOUBLE STRAND $12-\frac{1}{2}$ GA. TWISTED WIRE TO MATCH WITH FABRIC 14 GA., 4 PT. BARBS SPACED ON APPROXIMATELY 5" CENTERS.
- 10. GATE LATCH: $1-\frac{3}{8}$ " O.D. PLUNGER ROD WITH MUSHROOM TYPE CATCH AND LOCK, KEYED ALIKE FOR ALL SITES IN A GIVEN MTA.
- 11. COMPLY WITH ANY LOCAL ORDINANCES REQUIRING PERMITS FOR PLACEMENT OF BARBED
- 12. WARNING SIGNS USING THE INTERNATIONAL SYMBOL OF ELECTRICAL SHOCK HAZARD SHALL BE FURNISHED AND INSTALLED ON THE EXTERIOR OF ALL SIDES OF THE MAIN PERIMETER FENCE AND THE GATE. ADDITIONALLY, SIGNS SHALL BE FURNISHED AND INSTALLED THAT STATE "NO TRESPASSING" IN ENGLISH. THE SIGNS SHALL BE IMPERVIOUS TO WEATHERING AND BE MOUNTED TO AVOID EASE OF REMOVAL BY VANDALS.


TYPICAL WOVEN WIRE FENCING NOTES

NOT TO SCALE

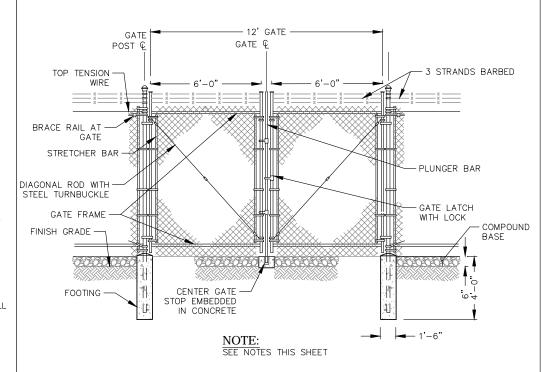


DOUBLE SWING GATE DETAIL

NOT TO SCALE

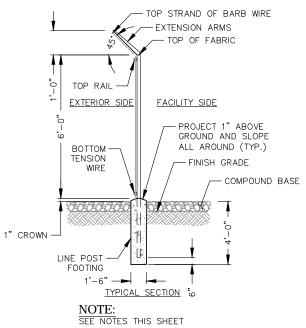

WOVEN WIRE FENCE DETAIL

NOT TO SCALE

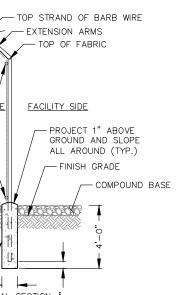

PROJECT:

HALLWAY 318965

No. 26868

PROFESSIONAL

verizon

3740 Davinci Ct. Suite 100

SEAL:

Peachtree Corners, GA 30092

w | www.fg-inc.net

f | 770.368.1944

LOCATED AT: 5182 ODUM SMALLWOOD RD GAINESVILLE, GA 30506


ADDDOVALC

	OVALS
CARRIER	
LANDLORD	
LEASING	
CONSTRUCTION	
REVISIONS	DATE
ISSUED FOR:	PERMIT/CONSTRUCTION
PROJECT MANAGER:	MWM
DDAMNO DV	ALIZ

DRAWING BY: DATE: 02/07/20 TITLE:

FENCE DETAILS

SHEET NUMBER: C-8JOB/FILE NUMBER: 1010.001

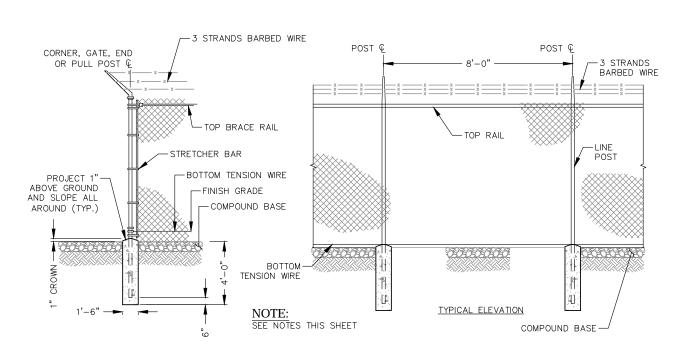


WOVEN WIRE CORNER, GATE, END OR PULL POST DETAIL

NOT TO SCALE



FORESITE group

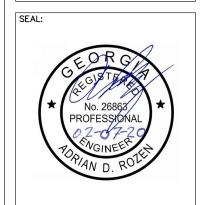

PROJECT:

DATE:

TITLE:

HALLWAY 318965

LOCATED AT: 5182 ODUM SMALLWOOD RD GAINESVILLE, GA 30506

APPR	OVALS
CARRIER	
LANDLORD	
LEASING	
CONSTRUCTION	
REVISIONS	DATE
ISSUED FOR:	PERMIT/CONSTRUCTION
PROJECT MANAGER:	MWM
DRAWING BY	ΔI K

GENERATOR DETAILS

02/07/20

SHEET NUMBER: C-9

JOB/FILE NUMBER: 1010.001

ELECTRICAL INSTALLATION NOTES

- 1. ALL ELECTRICAL WORK SHALL BE PERFORMED IN ACCORDANCE WITH THE PROJECT SPECIFICATIONS, NEC AND ALL APPLICABLE LOCAL CODES.
- 2. ALL ELECTRICAL EQUIPMENT AND ACCESSORIES SHALL BE U.L. APPROVED OR LISTED.
- 3. CONDUIT ROUTINGS ARE SCHEMATIC. CONTRACTOR SHALL INSTALL CONDUITS SO THAT ACCESS TO EQUIPMENT IS NOT BLOCKED.
- 4. WIRING, RACEWAY AND SUPPORT METHODS AND MATERIALS SHALL COMPLY WITH THE REQUIREMENTS OF THE NEC.
- 5. ALL CIRCUITS SHALL BE SEGREGATED AND MAINTAIN MINIMUM CABLE SEPARATION AS REQUIRED BY THE NEC.
- 6. CABLES SHALL NOT BE ROUTED THROUGH LADDER-STYLE CABLE TRAY RUNGS.
- 7. EACH END OF EVERY POWER, POWER PHASE CONDUCTOR (I.E., HOTS), GROUNDING, AND T1 CONDUCTOR AND CABLE SHALL BE LABELED WITH COLOR-CODED INSULATION OR ELECTRICAL TAPE (3M BRAND, 1/2 INCH PLASTIC ELECTRICAL TAPE WITH UV PROTECTION, OR EQUAL). THE IDENTIFICATION METHOD SHALL CONFORM WITH NE & OSHA.
- 8. ALL ELECTRICAL COMPONENTS SHALL BE CLEARLY LABELED WITH ENGRAVED LAMACOID PLASTIC LABELS. ALL EQUIPMENT SHALL BE LABELED WITH THEIR VOLTAGE RATING, PHASE CONFIGURATION, WIRE CONFIGURATION, POWER OR AMPACITY RATING, AND BRANCH CIRCUIT ID NUMBERS (IE., PANELBOARD AND CIRCUIT ID'S).
- 9. PANELBOARDS (ID NUMBERS) AND INTERNAL CIRCUIT BREAKERS (CIRCUIT ID NUMBERS) SHALL BE CLEARLY LABELED WITH ENGRAVED LAMACOID PLASTIC LABELS.
- 10. POWER, CONTROL, AND EQUIPMENT GROUND WIRING IN TUBING OR CONDUIT SHALL BE SINGLE CONDUCTOR (#14 AWG OR LARGER), 600 V. OIL RESISTANT THHN OR THWN-2 OR XHHW-2. STRANDED COPPER CABLE RATED FOR 90'C (WET AND DRY) OPERATION: LISTED OR LABELED FOR THE LOCATION AND RACEWAY SYSTEM USED, UNLESS OTHERWISE SPECIFIED.
- 11. POWER AND CONTROL WIRING, NOT IN TUBING OR CONDUIT, SHALL BE MULTI-CONDUCTOR, TYPE USE-2 CABLE (314 AWG OR LARGER), 600 V, OIL RESISTANT RHW-2 OR XHHW-2, STRANDED COPPER CABLE RATED FOR 90'C (WET AND DRY) OPERATION; WITH OUTER JACKET; LISTED OR LABELED FOR THE LOCATION USED, UNLESS OTHERWISE SPECIFIED.
- 12. ALL POWER AND GROUNDING CONNECTIONS SHALL BE CRIMP-STYLE, COMPRESSION WIRE LUGS AND WIRE NUTS BY THOMAS AND BETTS (OR EQUAL). LUGS AND WIRE NUTS SHALL BE RATED FOR OPERATION AT NO LESS THAN 90'C.
- 13. RACEWAY AND CABLE TRAY SHALL BE LISTED OR LABELED FOR ELECTRICAL USE IN ACCORDANCE WITH NEMA, UL, ANSI/IEEE, AND
- 14. ELECTRICAL METALLIC TUBING (EMT) OR RIGID METALLIC CONDUIT (RMC) SHALL BE USED FOR EXPOSED INDOOR LOCATIONS.
- 15. ELECTRICAL METALLIC TUBING (EMT) OR RIGID METALLIC CONDUIT (RMC) SHALL BE USED FOR CONCEALED INDOOR LOCATIONS.
- 16. RIGID NON-METALLIC CONDUIT (I.E., RIGID PVC SCHEDULE 80) SHALL BE USED UNDERGROUND; DIRECT BURIED, IN AREAS OF OCCASIONAL LIGHT VEHICLE TRAFFIC OR IN ARES OF HEAVY VEHICLE TRAFFIC. GALVANIZED RIGID CONDUIT SHALL BE USED.
- 17. ALL OUTDOOR EXPOSED CONDUIT SHALL BE RMC AND SHALL BE SUPPORTED ADEQUATELY.
- 18. LIQUID-TIGHT FLEXIBLE METALLIC CONDUIT LTMC) SHALL BE USED INDOORS AND OUTDOORS, WHERE VIBRATION OCCURS OR FLEXIBILITY IS NEEDED. LFMC SHALL CONFORM TO NEC ARTICLE 350.
- 19. CONDUIT AND TUBING FITTINGS SHALL BE THREADED OR COMPRESSION-TYPE AND APPROVED FOR THE LOCATION USED. SET SCREW FITTINGS ARE NOT ACCEPTABLE.
- 20. CABINETS, BOXES, AND WIREWAYS SHALL BE LISTED OR LABELED FOR ELECTRICAL USE IN ACCORDANCE WITH NEMA, UL, ANSI/IEEE, AND NEC.
- 21. WIREWAYS SHALL BE EPOXY-COATED (GRAY) AND INCLUDE A HINGED COVER, DESIGNED TO SWING OPEN DOWNWARD; SHALL BE PANDUIT TYPE E (OR EQUAL); AND RATED NEMA 1 (OR BETTER) INDOORS, OR NEMA 3R (OR BETTER) OUTDOORS.
- 22. EQUIPMENT CABINETS, TERMINAL BOXES, JUNCTION BOXES, AND PULL BOXES SHALL BE GALVANIZED OR EPOXY-COATED SHEET STEEL, SHALL MEET OR EXCEED UL 50, AND RATED NEMA 1 (OR BETTER) INDOORS, OR WEATHER PROTECTED (WP OR BETTER)
- 23. METAL RECEPTACLE, SWITCH, AND DEVICE BOXES SHALL BE GALVANIZED, EPOXY-COATED, OR NON-CORRODING; SHALL MEET OR EXCEED UL 514A AND NEMA OS 1 (OR BETTER) INDOORS. OR WEATHER PROTECTED (WP OR BETTER) OUTDOORS.
- 24. NON-METALLIC RECEPTACLE, SWITCH, AND DEVICE BOXES SHALL MEET OR EXCEED NEMA OS 2; AND RATED NEMA 1 (OR BETTER) INDOORS, OR WEATHER PROTECTED (WP OR BETTER) OUTDOORS.
- 25. CONTRACTOR SHALL APPLY FOR ELECTRICAL SERVICE AS SOON AS POSSIBLE AND COORDINATE REQUIREMENTS, SERVICE ROUTING, AND METER SOCKET TYPE WITH LOCAL POWER COMPANY.

ELECTRICAL INSTALLATION NOTES (CONT.)

- 26. CONTRACTOR SHALL APPLY FOR TELEPHONE SERVICE AS SOON AS POSSIBLE AND COORDINATE REQUIREMENTS AND SERVICE ROUTING WITH TELEPHONE COMPANY.
- 27. CONTRACTOR SHALL OBTAIN ALL PERMITS. PAY PERMIT FEES. AND SCHEDULE INSPECTIONS.
- 28. ALL SAFETY SWITCHES SHALL BE NEMA 1 FOR INDOOR, NEMA 3R FOR OUTDOOR, UL LISTED 200K SCCR RATED, REJECTION TYPE, WITH RK1 FUSES. FUSES SHALL HAVE AN AIR OF 200K AND SHALL HAVE A LIMITING RATING AS SHOWN IN THESE DRAWINGS. EQUIPMENT AND ACCESSORIES SHALL BE RATED FOR 75 DEGREES CELSIUS OR HIGHER.
- 29 ALL LOAD CENTERS SHALL BE 42 SPACE UNLESS NOTED OTHERWISE NEMA 1 FOR INDOOR NEMA 3R FOR OUTDOOR MCB WITH CONVERTIBLE MAINS, UL LISTED 22K IA OR HIGHER SCCR, WITH 22K AIR BREAKERS, BREAKERS AND LOAD CENTER SHALL BE RATED FOR 75 DEGREES CELSIUS OR HIGHER. BREAKERS SHALL HAVE A LIMITING RATING AS SPECIFIED ON THESE
- 30. CONTRACTOR SHALL LABEL ELECTRICAL EQUIPMENT IN ACCORDANCE WITH NEC 110.16 AND 110.24.
- 31. CONTRACTOR SHALL VERIFY THAT THE MAIN BONDING JUMPER AND GROUNDING ELECTRODE CONDUCTOR IS INSTALLED PROPERLY AT SERVICE ENTRANCE.
- 32. CONTRACTOR SHALL SEAL AROUND ALL CONDUIT PENETRATIONS TO PREVENT MOISTURE PENETRATION OR VERMIN
- 33. DURING TRENCH BACK-FILLING FOR EACH UNDERGROUND ELECTRICAL, TELEPHONE, SIGNAL AND COMMUNICATIONS LINE, PROVIDE A CONTINUOUS UNDERGROUND WARNING TAPE TWELVE INCHES BELOW FINISHED GRADE.

GROUNDING NOTES

- 1. ALL GROUNDING CONNECTIONS SHALL BE MADE USING EXOTHERMIC WELDING PROCESS (CAD WELD OR EQUAL) EXCEPT FOR EQUIPMENT THAT MAY BE MECHANICALLY FASTENED. ALL LUGS SHALL BE TWO HOLE, LONG BARREL TYPE, FOR COPPER, UNLESS OTHERWISE
- 2. ALL GROUND PLATES SHALL BE INSTALLED AT 30" BELOW GRADE PER MANUFACTURER'S SPECIFICATIONS. UNDERGROUND GROUNDING CONDUCTORS SHALL BE 30" BELOW GRADE.
- 3. ALL GROUND CONDUCTORS SHALL BE MIN. #2 AWG SOLID TINNED COPPER WIRE BARE. EQUIPMENT GROUND CONDUCTORS SHALL BE MIN. #6 GREEN INSULATED, UNLESS OTHERWISE NOTED.
- 4. GROUND PLATES FOR GROUND RING SHALL BE LOCATED 5'-0" APART.
- 5. ANY METAL OBJECT WITHIN 6 FEET OF THE TOWER OR EQUIPMENT GROUND RING SHALL BE BONDED DIRECTLY TO THE RING.
- 6. THE MINIMUM BENDING RADIUS FOR ALL GROUNDING CONDUCTORS #6 AWG OR LARGER SHALL BE 24".
- 7. ALL ABOVE GRADE GROUND CONDUCTORS SHALL BE ROUTED DOWNWARD TOWARD EARTH AND HORIZONTAL ONLY WHERE NECESSARY.
- 8. ALL CONDUCTORS SHALL BE ROUTED SUCH THAT THERE ARE NO INCLUSIVE ANGLES OF LESS THAN 90 DEGREES.
- 9. THE CONTRACTOR SHALL PERFORM IEEE FALL-OF-POTENTIAL RESISTANCE TO EARTH TESTING (PER IEEE 1100 AND 81) FOR GROUND ELECTRODE SYSTEMS. THE SUBCONTRACTOR SHALL FURNISH AND INSTALL SUPPLEMENTAL GROUND ELECTRODES AS NEEDED TO ACHIEVE A RECOMMENDED TEST RESULT OF 5 OHMS OR LESS.
- 10. ALL GROUNDING SHALL COMPLY WITH THE N.E.C. AND NFPA 780. "LIGHTING PROTECTION CODE".
- 11. ALL GROUNDING COMPONENTS SHALL BE FURNISHED AND INSTALLED BY CONTRACTOR.
- 12. ANY METAL CONDUIT MOUNTED ON THE TOWER SHALL BE BONDED TO THE TOWER AT EACH END.
- 13. ALL EXPOSED GROUNDING SHALL BE IN NON-METALLIC FLEX CONDUIT AND SECURED AS NECESSARY.
- 14. WHEN BONDING TO EQUIPMENT, REMOVE PAINT TO BARE STEEL AND PROTECT WITH A COATING OF NO-OX.
- 15. APPROVED ANTIOXIDANT COATINGS SHALL BE USED ON ALL COMPRESSION AND BOLTED GROUND CONNECTIONS.
- 16. BOND ICE BRIDGE SECTIONS TOGETHER EXOTHERMICALLY OR WITH 2 HOLE LUGS. BOND ICE BRIDGE TO SUPPORT POSTS.
- 17. THESE NOTES ARE NOT ALL-ENCOMPASSING. REFER TO VERIZON STANDARDS FOR COMPLETE GROUNDING GUIDELINES





3740 Davinci Ct f | 770.368.1944 Peachtree Corners GA 30095



PROJECT:

HALLWAY 318965

LOCATED AT: 5182 ODUM SMALLWOOD RD GAINESVILLE, GA 30506

APPR	ROVALS
CARRIER	
LANDLORD	
LEASING	
CONSTRUCTION	
REVISIONS	DATE
ISSUED FOR:	PERMIT/CONSTRUCTION

PROJECT MANAGER: MWM DRAWING BY: AIK DATE: 02/07/20 TITLE:

ELECTRICAL NOTES

SHEET NUMBER E-1JOB/FILE NUMBER: 1010.001

NOTE: PANEL SCHEDULE AND SINGLE LINE DIAGRAM REPRESENT A SITE WITH A NEW GE POWER PLANT, 30 KW DIESEL GENERATOR, AND TWO SOURCE ILC (THREE SOURCE ILC OPTIONAL AS NEEDED). ADJUST AS NECESSARY PER LOCAL SITE CONDITIONS

> TO UTILITY TRANSFORMER

> > M

3-#3/0 AWG

(130 LF MAX)

200A ILC

200A)200A

INTEGRATED LOAD CENTER

#6 AWG EG 2" CONDUIT

(OPTIONAL) C

VERIZON WIRELESS ILC

CABINET WITH 2P/200A UTILITY BREAKER AND

OPTIONAL 2P/200A CAM LOCK BREAKER

MECHANICALLY INTERLOCKED WITH WALKING BEAM TRANSFER SWITCH AND 30 POSITION

LOAD CENTER

UTILITY METER

LOAD CAI	CULATION	
LOAD	AMPS	
PROPOSED LOAD:	140.0	
TOTAL DEMAND:	140.0	
VOLTAGE: 120/240V SINGLE PHASE 3W 200A		

NAM	L:				INOWRF	K:									
RATE VOLT	D AGE:	240	120	VOLTS	PHASE,	/WIRE:	1	3							
MAIN		200	AMPS		BUS RATING		20	00			KEY DOOR LATCH:	YES			
MOUI		SURF	ACE		NEUTRA BAR:	AL.	YE	S			HENGED DOOR:	YES	1		
ENCL TYPE	OSURE	NEMA	3R		AIC:		6	5K							
	USAGE	BUS	AMPS	1010	50, 50					50,50	1015	BUS	AMPS	USAGE	200
POS	FACTOR	L1	L2	LOAD	POLES	AMPS	L1	L2	AMPS	POLES	LOAD	L1	L2	USAGE FACTOR	POS
1	1	18		DEOTIFIED		70.			30A		FUTURE	18		1	2
3	1		18	RECTIFIER	2	30A			30A	2	RECTIFIER		18	1	4
5	1	18		RECTIFIER	2	30A	\overline{Z}		30A	,	FUTURE	18		1	6
7	1		18	RECTIFIER	2	JUA			JUA	2	RECTIFIER		18	1	8
9	1	18		RECTIFIER	2	30A								1	10
11	1		18	RECTIFIER		JUA								1	12
13	1	18		RECTIFIER	2	30A									14
15	1		18		2	JUA									16
17	1.25	16		GFI RECEPT. /LIGHT	1	20A									18
19	1		16	BLOCK HEATER	1	20A									20
21	1	16		BATT. CHARGER	1	20A									22
23															24
25															26
27															28
29															30
		104	88	:SUB TOTAL AMPS				•			SUB TOTAL AMPS:	36	36		
											FACTORED TOTAL AMPS:	140	124		

ASCO D300L SERIES

VZW ILC

OTES:

ALL CONDUCTORS ARE TYPE THWN (75°C) COPPER.


MAXIMUM LENGTH OF RUN FOR RECTIFIER CIRCUITS IS 50FT.

ASCO INTEGRATED LOAD CENTER INCLUDES 200 AMP MAIN DISCONNECT AND TRANSFER SWITCH FOR PORTABLE OR PERMANENT GENERATOR.

RECTIFIER LOADS ARE CONSIDERED TO BE NON-CONTINUOUS.

IF ADDITIONAL FUTURE LOADS ARE ADDED WHICH CAUSE TOTAL DEMAND TO EXCEED GENERATOR BREAKER SIZE, BACKUP POWER SYSTEM SHALL BE EVALUATED AND UPGRADED AS NECESSARY.

PANEL SCHEDULE

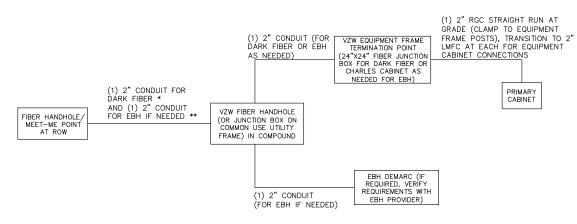

FIBER SINGLE LINE DIAGRAM

- ** ADD (1) ADDITIONAL 2" CONDUIT FOR DARK FIBER (2 TOTAL) IF REQUIRED BY LOCAL MARKET FACILITIES, VERIFY PRIOR TO CONSTRUCTION. (ADD 2 PULL STRINGS TO EACH CONDUIT)
- ** VERIFY EBH REQUIREMENTS WITH TELCO PROVIDER PRIOR TO CONSTRUCTION. (ADD 2 PULL STRINGS TO EACH CONDUIT)

ELECTRICAL SINGLE LINE DIAGRAM

- NOTES:

 1. ALL EQUIPMENT SHALL BE NEMA 3R RATED.
 2. ALL EQUIPMENT SHALL BE LIGHTNING PROTECTED IN ACCORDANCE WITH TIA-222-H AND VERIZON WIRELESS STANDARDS.

GEN MAIN

DISCONNECT/ FUSED SWITCH

150A

30KW GEN

VERIZON WIRELESS 30KW DIESEL GENERATOR

30KW 120/240 V, DIESEL GENERATOR WITH 150A MAIN BREAKER. GENERATOR IS IN A

NEMA 3R ENCLOSURE SUPPLIED WITH 1500W 120V BLOCK HEATER.

NOTE: THE GENERATOR USED IN

CONJUNCTION WITH A 2-POLE ILC WITH A SOLID NEUTRAL IS NOT A
SEPARATELY DERIVED SYSTEM. AS
SUCH, DO NOT BOND THE NEUTRAL
TO GROUND AT THE GENERATOR

3-#1/0 AWG 6 AWG EG

1-1/2" CONDUIT

(185 LF MAX)

1" CONDUIT FOR GEN CONTROLS & ALARMS

GFCI RECPT.

LIGHT

4-#12 AWG,1-#12 AWG EG, 1" CONDUIT (FOR GEN HEATER & BATT. CHARGER)

3-#12 AWG #12 AWG EG 1" CONDUIT

1" CONDUIT FOR GEN & ILC ALARMS

8-#10 AWG, 1-#10 AWG EG, IN (1) 1-1/2" CONDUIT (INSTALL (1) 1-1/2" CONDUIT WITH PULL STRING

FOR FUTURE RECTIFIER CIRCUITS) ROUTE CONDUIT

ABOVE GROUND SECURED TO EQUIPMENT FRAME


- 2. ALL LOUINING THE LET BE THAT BEEN SIZED FOR 3% MAX VOLTAGE DROP (TOTAL SYSTEM VOLTAGE DROP ON BOTH FEEDERS AND BRANCH CIRCUITS TO THE FARTHEST DEMAND SHALL NOT EXCEED 5%)
 4. WIRE SIZING AND MAXIMUM DISTANCE FROM GENERATOR TO ILC ASSUMES POWER FACTOR OF 0.9,
 5. BELOW GRADE CONDUIT SHALL BE SCHEDULE 80 PVC. ABOVE GRADE CONDUIT SHALL BE GALVANIZED RIGID CONDUIT. BELOW GRADE PVC CONDUIT SHALL TRANSITION TO GRC PRIOR TO RISING ABOVE GRADE. ALL BENDS SHALL HAVE A MINIMUM 24" RADIUS. ALL FITTINGS SHALL BE SUITABLE FOR USE WITH THREADED RIGID CONDUIT. VERIFY CONDUIT TYPE WITH LOCAL CONSTRUCTION MANAGER AND ADJUST IF NECESSARY. ALL CONDUIT SHALL MET NEC, STATE, AND LOCAL CODE

ELECTRICAL DETAILS



w | www.fg-inc.net

3740 Davinci Ct. Suite 100 f | 770.368.1944 Peachtree Corners, GA 30092

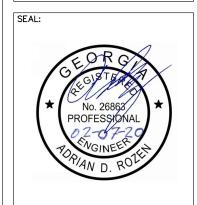

PROJECT:

HALLWAY 318965

LOCATED AT: 5182 ODUM SMALLWOOD RD GAINESVILLE, GA 30506


APPR	OVALS
CARRIER	
LANDLORD	
LEASING	
CONSTRUCTION	
REVISIONS	DATE
ISSUED FOR:	PERMIT/CONSTRUCTION
PROJECT MANAGER:	MWM
DRAWING BY:	ALK
DATE:	02/07/20

ONE-LINE DIAGRAM & PANEL SCHEDULE

SHEET NUMBER:

TITLE:

JOB/FILE NUMBER: 1010.001

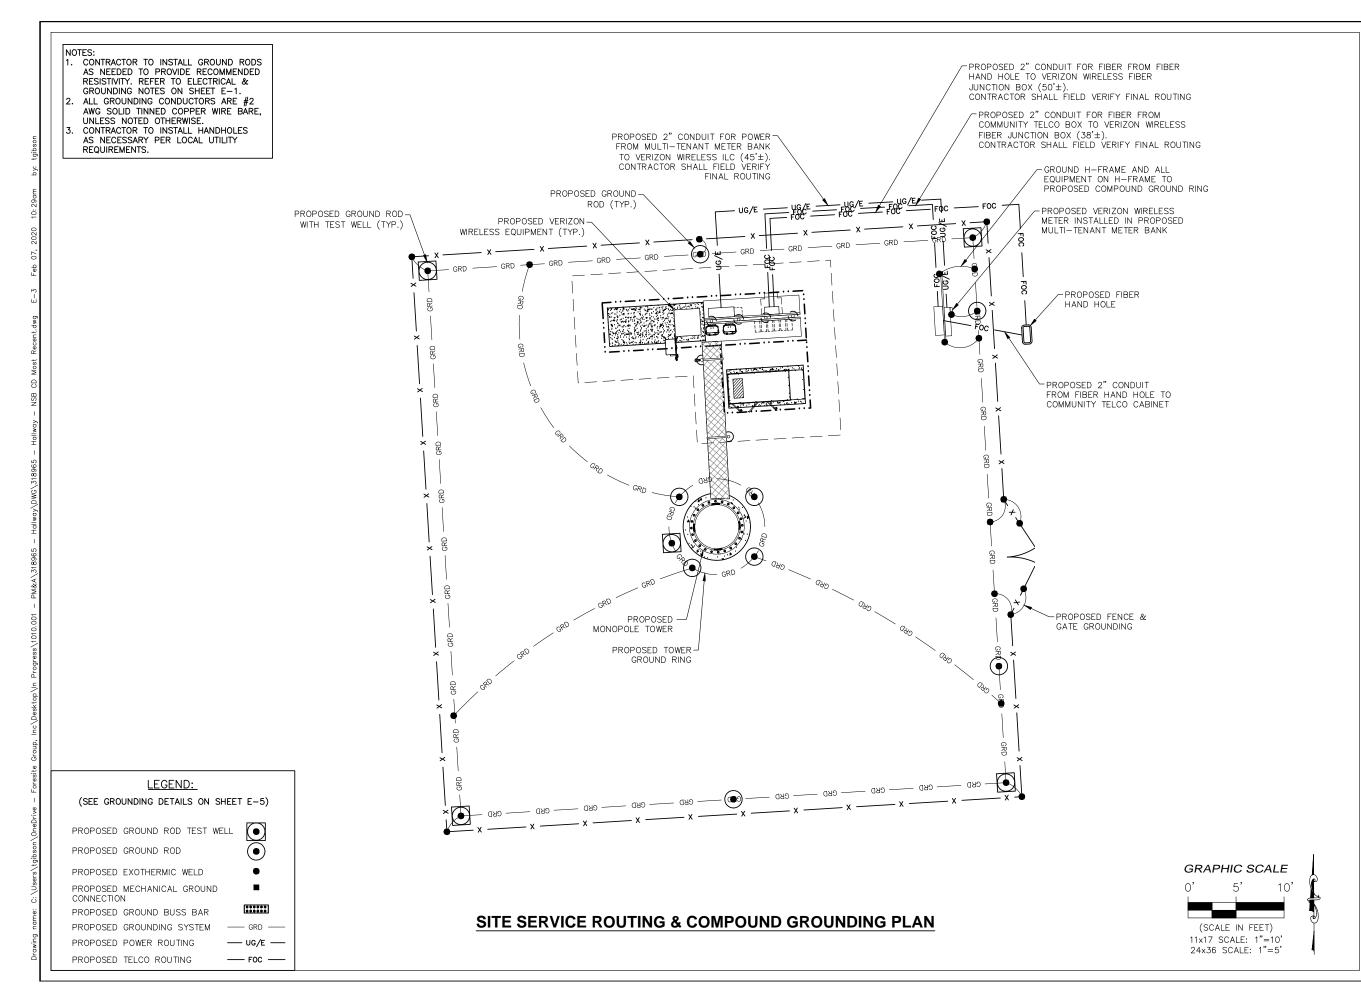





3740 Davinci Ct. Suite 100

w | www.fg-inc.net o | 770.368.1399 f | 770.368.1944 Peachtree Corners, GA 30092

SEAL:



PROJECT:

HALLWAY 318965


LOCATED AT: 5182 ODUM SMALLWOOD RD GAINESVILLE, GA 30506

APPROVALS CARRIER LANDLORD LEASING CONSTRUCTION REVISIONS DATE

ISSUED FOR: PERMIT/CONSTRUCTION PROJECT MANAGER: MWM DRAWING BY: ALK DATE: 02/07/20

> SITE SERVICE ROUTING & COMPOUND GROUNDING PLAN

SHEET NUMBER: JOB/FILE NUMBER: 1010.001

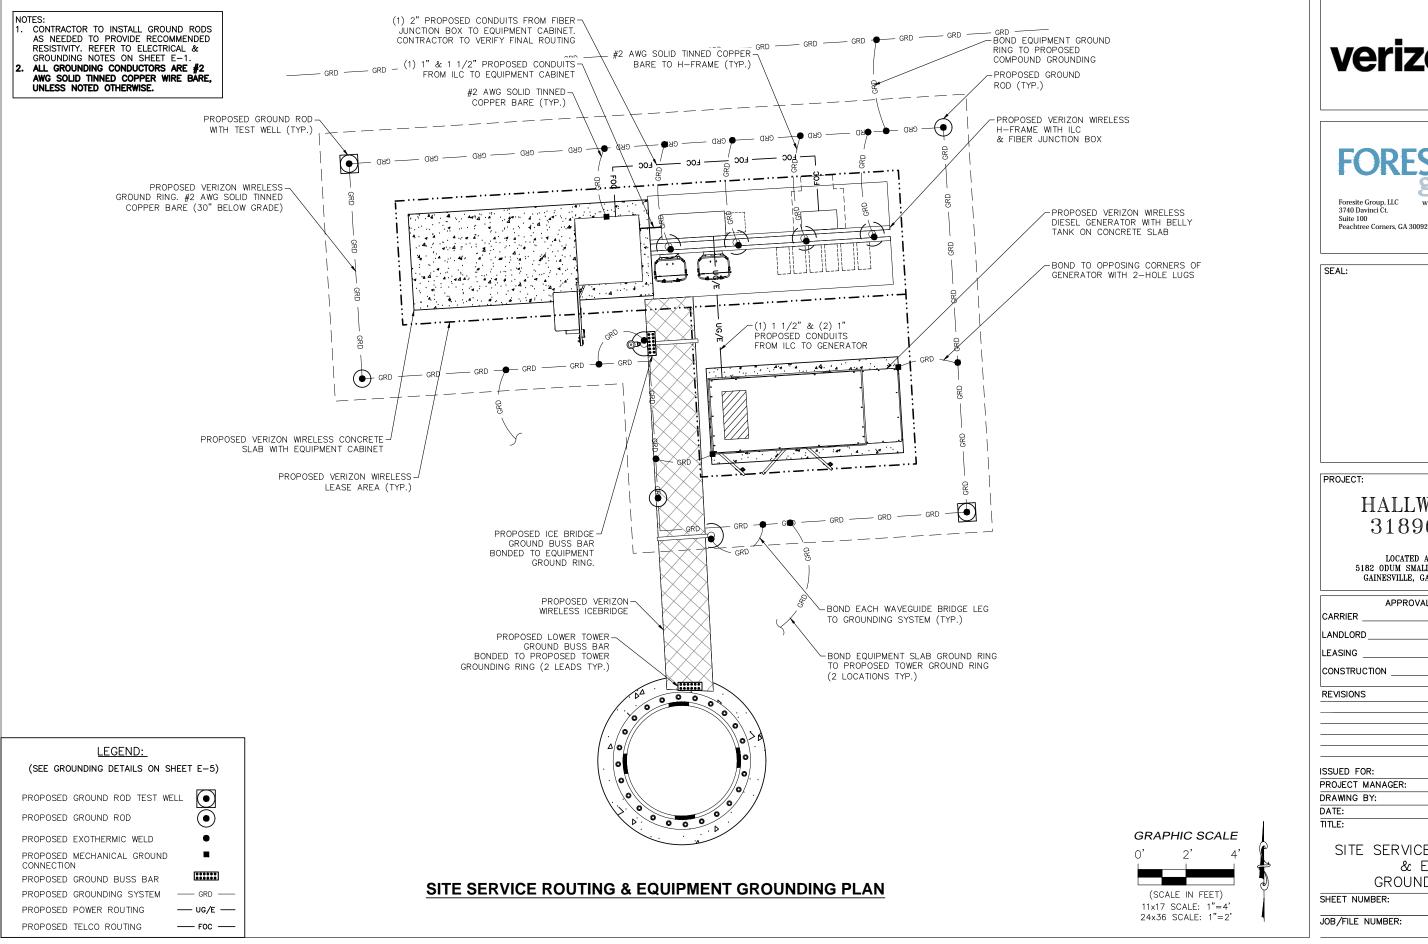





w | www.fg-inc.net o | 770.368.1399 f | 770.368.1944

HALLWAY 318965


LOCATED AT: 5182 ODUM SMALLWOOD RD GAINESVILLE, GA 30506

APPROVALS	
CARRIER	
LANDLORD	
LEASING	
CONSTRUCTION	
REVISIONS	DATE

ISSUED FOR:	
PROJECT MANAGER:	MWM
DRAWING BY:	ALK
DATE:	02/07/20
TITLE:	

SITE SERVICE ROUTING & EQUIPMENT GROUNDING PLAN

E-41010.001

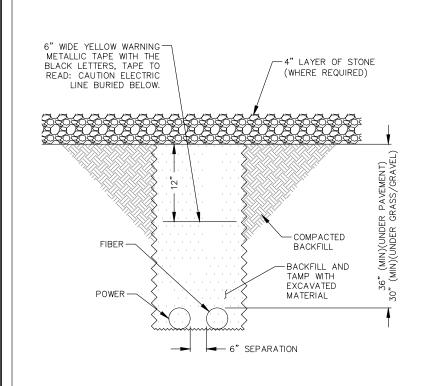


(RIGID STEEL CONDUIT COUPLING CRADE

RIGID STEEL CONDUIT COUPLING

GRADE

RIGID STEEL TO PVC ADAPTOR

RIGID STEEL TO PVC CONDUIT 2" SCHEDULE 80 PVC CONDUIT

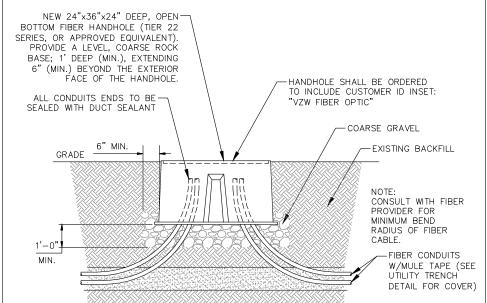


verizon /

FORESITE group

Foresite Group, LLC | w | www.fg.inc.net 3740 Davinci Ct. | o | 770.368.1399 Suite 100 | f | 770.368.1944 Peachtree Corners. GA 30092

SEAL:

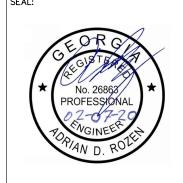

UTILITY TRENCH DETAIL


NOT TO SCALE

UNDERGROUND CONDUIT STUB-UP

NOT TO SCALE


FIBER HANDHOLE DETAIL

NOT TO SCALE

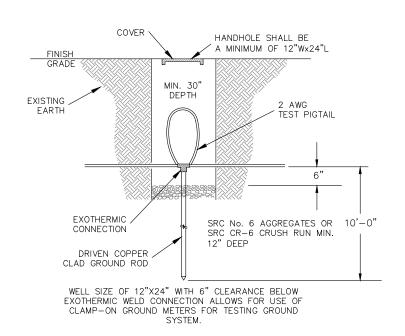

GROUND ROD TEST WELL DETAIL

NOT TO SCALE

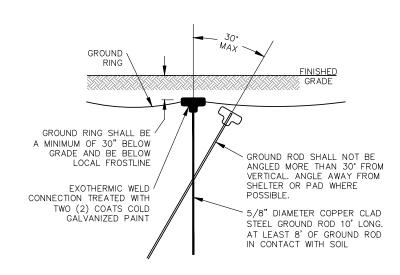

GROUND ROD DETAIL

NOT TO SCALE

PROJECT:

HALLWAY 318965

LOCATED AT: 5182 ODUM SMALLWOOD RD GAINESVILLE, GA 30506

APPROVALS

CARRIER	
LANDLORD	
LEASING	
CONSTRUCTION	
REVISIONS	DATE
ISSUED FOR:	PERMIT/CONSTRUCTION
PROJECT MANAGER	R: MWM

DRAWING BY:

DATE:

02/07/20


IITLE:

GROUNDING DETAILS


SHEET NUMBER: E-5

JOB/FILE NUMBER: 1010.001

One-Prive - Foresite Groun Inc\Deskton\In Progress\1010 001 - PM&A\3189

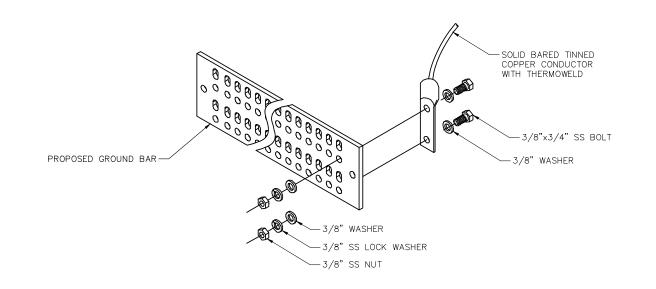

TYP. GROUND BAR CONNECTION DETAIL NOT TO SCALE

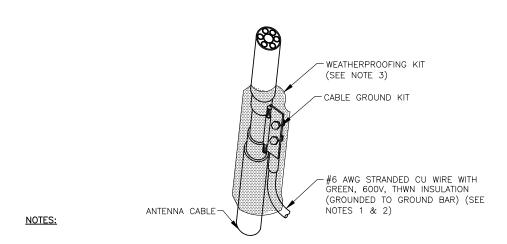

- 1. DO NOT INSTALL CABLE GROUND KIT AT A BEND AND ALWAYS DIRECT GROUND WIRE DOWN TO GROUND BAR.
- 2. GROUNDING KIT SHALL BE TYPE AND PART NUMBER AS SUPPLIED OR RECOMMENDED BY CABLE MANUFACTURER.
- 3. WEATHERPROOFING SHALL BE TYPE AND PART NUMBER AS SUPPLIED OR RECOMMENDED BY CABLE MANUFACTURER.


CONNECTION OF GROUND KIT TO ANTENNA CABLE

NOT TO SCALE



w | www.fg-inc.net o | 770.368.1399 3740 Davinci Ct. Suite 100 f | 770.368.1944 Peachtree Corners, GA 30092

SEAL:

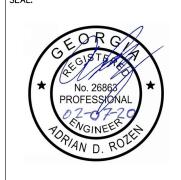

PROJECT:

DRAWING BY:

DATE: TITLE:

HALLWAY 318965

LOCATED AT: 5182 ODUM SMALLWOOD RD GAINESVILLE, GA 30506


APPR	OVALS
CARRIER	
LANDLORD	
LEASING	
CONSTRUCTION	
REVISIONS	DATE
SSUED FOR:	PERMIT/CONSTRUCTION
PROJECT MANAGER:	MWM

GROUNDING DETAILS SHEET NUMBER: E-6

JOB/FILE NUMBER: 1010.001

ALK 02/07/20



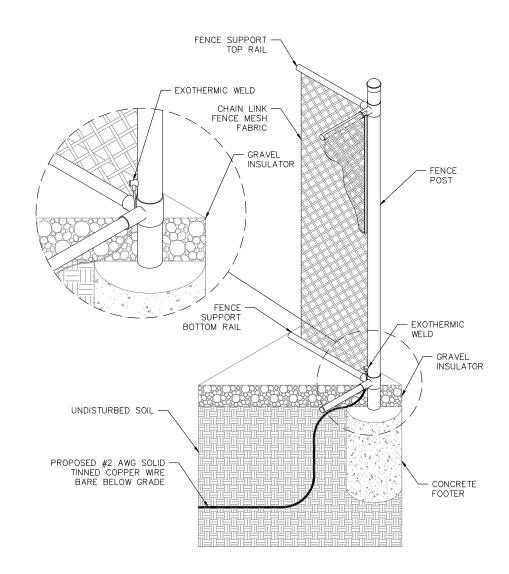





Foresite Group, ILC | w | www.fg-inc.net 3740 Davinci Ct. | o | 770.368.1399 Suite 100 | f | 770.368.1944 Peachtree Corners, GA 30092

SEAL: No. 26863 PROFESSIONAL

PROJECT:

TITLE:

HALLWAY 318965

LOCATED AT: 5182 ODUM SMALLWOOD RD GAINESVILLE, GA 30506

APPR	APPROVALS				
CARRIER					
LANDLORD					
LEASING					
CONSTRUCTION					
REVISIONS	DATE				
ISSUED FOR:	PERMIT/CONSTRUCTION				
PROJECT MANAGER:	MWM				
DRAWING BY:	ALK				
DATE:	02/07/20				

GROUNDING DETAILS SHEET NUMBER:

JOB/FILE NUMBER: 1010.001


FENCE AND GATE GROUNDING DETAIL NOT TO SCALE


- GATE POST

- CONCRETE FOOTER

NOTES:

- 1. CONTRACTOR TO FIELD LOCATE THE METER PEDESTAL AS SHOWN ON SITE PLAN. INSTALL THE METER PEDESTAL NEAR THE PERIMETER OF THE FENCED COMPOUND WITH THE METERS FACING AS SHOWN.
- 2. THE CONTRACTOR SHALL COORDINATE THE THE LOCAL UTILITY COMPANY FOR THE CONDUIT RUN TO THE MAIN SERVICE CONNECTION OR TRANSFORMER.
- 3. THE CONTRACTOR SHALL COORDINATE THE THE LOCAL UTILITY COMPANY FOR GROUND ROD REQUIREMENTS. IF REQUIRED, THE CONTRACTOR SHALL ORDER AND PAY FOR NECESSARY GROUND TESTS.
- 4. SUPPORT POST AND UNISTRUT SHALL BE GALVANIZED. PIPE CLAMPS AND HARDWARE SHALL BE GALVANIZED OR STAINLESS STEEL.
- 5. TELCO CABINET SHALL BE A 48"x48"x12" HOFFMAN OR EQUIVALENT. PROVIDE 3/4" PLYWOOD BACKBOARD INSIDE THE MULTI-TENANT TELCO CABINET.
- ADJUSTMENTS TO THE METER PEDESTAL DESIGN MAY BE REQUIRED DEPENDING ON THE EXACT METER PANEL INSTALLED. CONTRACTOR SHALL FIELD COORDINATE ADJUSTMENTS AND INFORM THE ENGINEER IF ANY UNUSUAL CONDITIONS ARE FOUND TO EXIST.

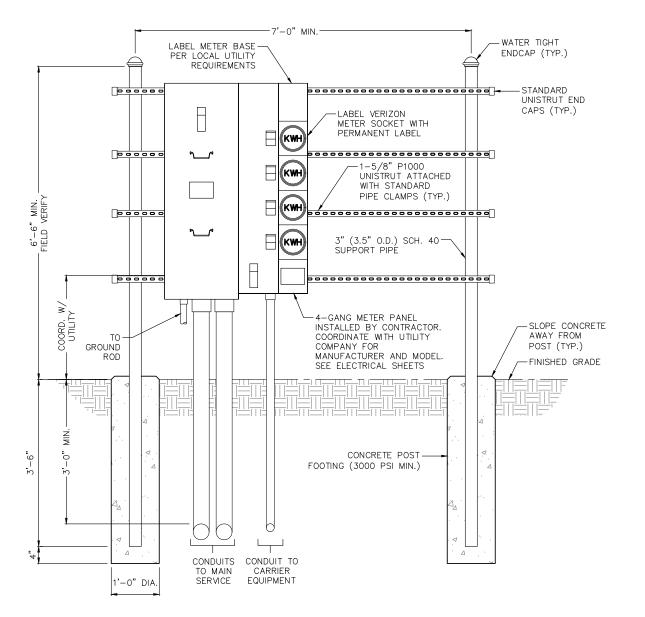

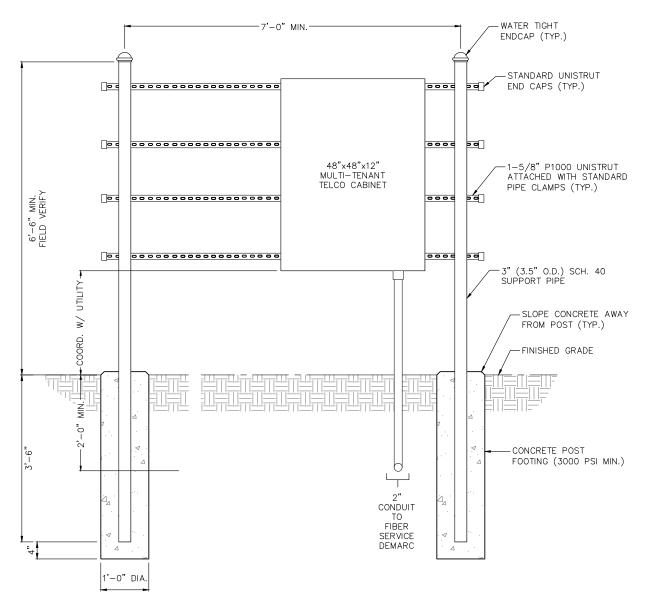


UTILITY H-FRAME DETAIL (GANG METER) NOT TO SCALE

UTILITY H-FRAME DETAIL (TELCO) NOT TO SCALE



w | www.fg-inc.net 3740 Davinci Ct. Suite 100

f | 770.368.1944 Peachtree Corners, GA 30092

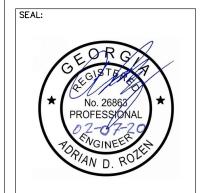

PROJECT:

DATE:

TITLE:


HALLWAY 318965

LOCATED AT: 5182 ODUM SMALLWOOD RD GAINESVILLE, GA 30506

	APPROVALS				
	CARRIER				
LANDLORD					
	LEASING				
	CONSTRUCTION				
	REVISIONS	DATE			
	ISSUED FOR:	PERMIT/CONSTRUCTION			
	PROJECT MANAGER:	MWM			
	DRAWING BY:	ALK			

UTILITY H-FRAME DETAILS SHEET NUMBER: E-8JOB/FILE NUMBER: 1010.001

02/07/20

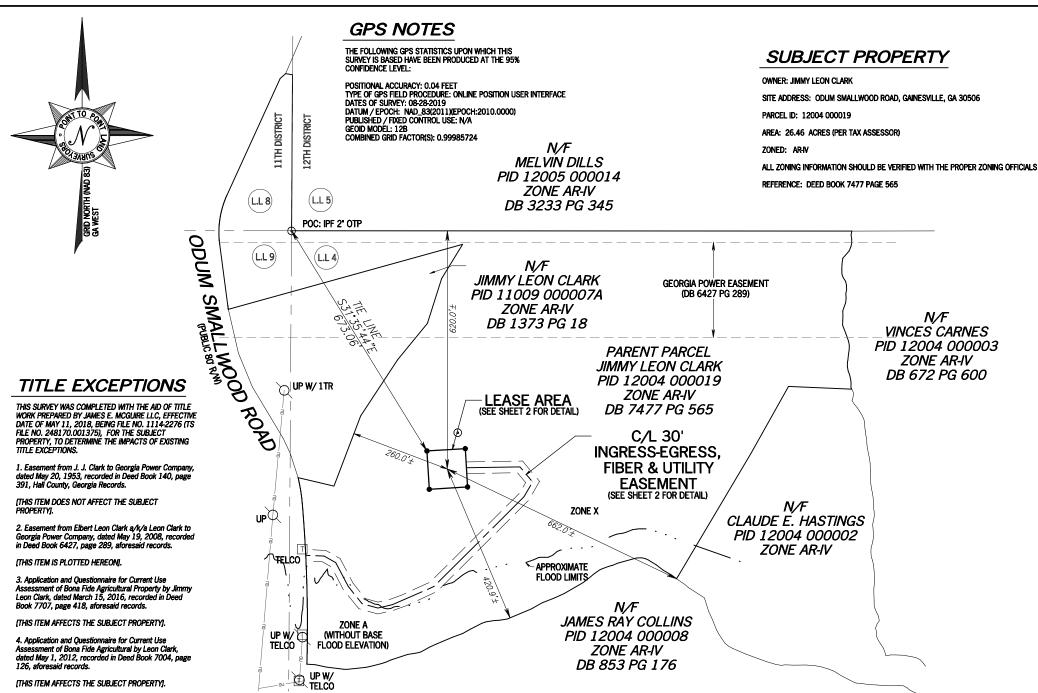

SUBJECT PROPERTY

(AS PROVIDED IN TITLE REPORT FILE NO. 1114-2276)


ALL THAT TRACT OR PARCEL OF LAND LYING AND BEING IN LAND LOTS 8 AND 9 OF THE 11TH DISTRICT AND LAND LOT 4 OF THE 12TH DISTRICT OF HALL COUNTY, GEORGIA, AND CONTAINING 26.46 ACRES, ACCORDING TO THE HALL COUNTY TAX ASSESSOR (THE "ASSESSOR"), AND BEING MORE PARTICULARLY DESIGNATED BY THE ASSESSOR AS PARCEL ID 120040000019 AND HAVING A PARCEL ID ADDRESS OF 5182 ODUM SMALLWOOD ROAD, SAID PARCEL ID, SUBJECT TO SURVEY CERTIFICATION, APPEARS TO BE A PORTION OF THE BELOW DESCRIBED THREE TRACTS OF REAL **ESTATE. AS FOLLOWS:**

TRACT ONE: THIRTY EIGHT AND ONE HALF ACRES OF LAND WITH ALL IMPROVEMENTS THEREON LOCATED IN QUILLIAN'S DISTRICT OF HALL COUNTY, GEORGIA IN THE 11TH LAND DISTRICT OF SAID COUNTY, THE SAME BEING PARTS OF LOT NOS. 4 AND 5 IN SAID DISTRICT AND MORE FULLY DESCRIBED IN A DEED FROM S. A. TRUELOVE TO J. J. AND MRS. J. J. CLARK DATED MARCH 14, 1942 AND RECORDED IN HALL COUNTY DEED RECORDS IN DEED BOOK 91, PAGE 273, REFERENCE TO WHICH IS MADE FOR A MORE COMPLETE DESCRIPTION.

TRACT TWO: FIFTEEN ACRES, MORE OR LESS, WITH ALL IMPROVEMENTS THEREON IN THE 11TH LAND DISTRICT OF HALL COUNTY, GEORGIA, QUILIIAN'S DISTRICT, THE SANE BEING MORE FULLY DESCRIBED IN A DEED FROM J. J. WILSON TO J. J. CLARK, DATED NOVEMBER 29, 1932 AND RECORDED IN HALL COUNTY DEED RECORDS IN DEED BOOK 63, PAGE 390, REFERENCE TO WHICH IS MADE FOR A MORE COMPLETE DESCRIPTION OF THE PROPERTY CONVEYED - LESS AND EXCEPT THEREFROM TWO SMALL PARCELS WHICH HAVE HERETOFORE BEEN CONVEYED BY THE GRANTOR, J. J. CLARK, TO RICHARD CLARK AND JIMMY CLARK AS WILL APPEAR FROM DEEDS ON RECORD IN HALL COUNTY, GEORGIA DEED RECORDS.

TRACT THREE: TWENTY FIVE ACRES, MORE OR LESS, IN QUILLIAN'S DISTRICT OF HALL COUNTY, GEORGIA AND BEING APART OF LOT 8 IN THE 11TH LAND DISTRICT OF HALL COUNTY, GEORGIA, THE SAME BEING MORE FULLY DESCRIBED IN A DEED FROM D. W. FAULKNER TO JESSE CLARK, DATED DECEMBER 14, 1929 AND RECORDED IN HALL COUNTY DEED RECORDS IN DEED BOOK 58 PAGE 210, REFERENCE TO WHICH IS MADE FOR A MORE COMPLETE DESCRIPTION OF THE TRACT HEREBY CONVEYED.

LESS AND EXCEPT THAT PORTION OF THE ABOVE DESCRIBED PROPERTY CONVEYED BY RIGHT OF WAY DEED FROM LEON CLARK TO HALL COUNTY, GEORGIA, DATED SEPTEMBER 26, 1989, RECORDED IN DEED BOOK 1408, PAGE 156, HALL COUNTY, GEORGIA RECORDS.

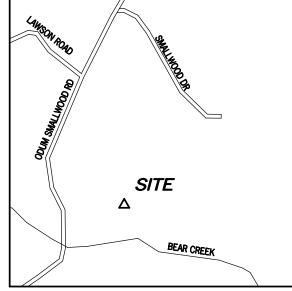

VICINITY MAP

NOT TO SCALE

GENERAL NOTES

THIS EXHIBIT SURVEY IS FOR THE LEASED PREMISES AND EASEMENTS ONLY. THIS EXHIBIT SURVEY WAS PREPARED FOR THE EXCLUSIVE USE OF VERIZON WIRELESS AND EXCLUSIVELY FOR THE TRANSFERRAL OF THE PROPOSED LEASED PREMISES AND THE RIGHTS OF EASEMENT SHOWN HEREON AND SHALL NOT BE USED AS AN EXHIBIT OR EVIDENCE IN THE FEE SIMPLE TRANSFERRAL OF THE PARENT PARCEL NOR ANY PORTION OR PORTIONS THEREOF, BOUNDARY INFORMATION SHOWN HEREON HAS BEEN COMPILED FROM TAX MAPS AND DEED DESCRIPTIONS ONLY.

THIS DRAWING DOES NOT REPRESENT A BOUNDARY SURVEY

THE FIELD DATA UPON WHICH THIS EXHIBIT SURVEY IS BASED HAS A CLOSURE PRECISION OF ONE FOOT IN 20,000+ FEET AND AN ANGULAR ERROR OF 5.0° PER ANGLE POINT AND WAS ADJUSTED USING LEAST SOURRES.

FOUIPMENT USED FOR ANGULAR & LINEAR MEASUREMENTS: LEICA TPS 1200

THE 1' CONTOURS AND SPOT ELEVATIONS SHOWN ON THIS EXHIBIT SURVEY ARE ADJUSTED TO NAVD 88 DATUM (COMPUTED USING GEOID 12B) AND HAVE A VERTICAL ACCURACY OF \pm 0.5'. CONTOURS OUTSIDE THE IMMEDIATE SITE AREA

BEARINGS SHOWN ON THIS EXHIBIT SURVEY ARE BASED ON GRID NORTH (NAD 83)


A PORTION OF THIS PROPERTY AND THE 30' FASEMENT IS LOCATED IN A SPECIAL FLOOD AREA "ZONE A" (WITHOUT BASE FLOOD ELEVATION) PER F.I.R.M. COMMUNITY PANEL NO. 13139C0087G DATED 04/04/2018.

NO WETLAND AREAS HAVE BEEN INVESTIGATED BY THIS EXHIBIT SURVEY.

ALL ZONING INFORMATION SHOULD BE VERIFIED WITH THE PROPER ZONING

ANY UNDERGROUND UTILITIES SHOWN HAVE BEEN LOCATED FROM ABOVE GROUND FIELD SURVEY INFORMATION. THE SURVEYOR MAKES NO GUARANTEES THAT ANY UNDERGROUND UTILITIES SHOWN COMPRISE ALL SUCH UTILITIES IN THE AREA, EITHER IN-SERVICE OR ABANDONED. THE SURVEYOR FURTHER DOES NOT WARRANT THAT ANY UNDERGROUND UTILITIES SHOWN ARE IN THE EXACT LOCATION INDICATED ALTHOUGH THEY ARE LOCATED AS ACCURATELY AS POSSIBLE FROM INFORMATION AVAILABLE. THE SURVEYOR HAS NOT PHYSICALLY LOCATED ANY UNDERGROUND UTILITIES.

CERTIFICATE OF AUTHORIZATION: LSF000843

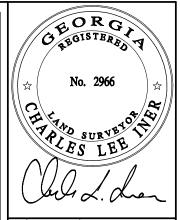

NO.	DATE	REVISION
1	06/08/2018	ADDED TITLE - NRW
2	06/10/2019	DIMENSIONS - NRW
3	09/04/2019	TREE LOCATION

SURVEYORS ernors Trace, Suite 103 ie City, GA 30269 is 5.4440 POIN.

100 Goverr Peachtree (p) 678.565 f) 678.565 AND 100 Œ.



EXHIBIT SURVEY PREPARED FOR:



10300 OLD ALABAMA ROAD CONNECTOR ALPHARETTA. GA 30022

HALLWAY

LAND LOT 4, 12TH DISTRICT HALL COUNTY, GEORGIA

DRAWN BY: RMF

CHECKED BY: JKL

APPROVED: C. INER DATE: MAY 7, 2018

P2P JOB #: 194051GA

GRAPHIC SCALE IN FEET SCALE: 1'' = 250'

SHEET:

SURVEY NOT VALID WITHOUT SHEET 2 OF

STORM DRAIN MANHOLE
NIVERT
FIRE HYDRANT
EDGE OF PAVEMENT
TOP OF CURB
BACK OF CURB
BACK OF CURB
TOP OF WALL
BOTTOM OF WALL
OVERHEAD UTILITY
UNDERGROUND UTILITY
UNDERGROUND UTILITY
CORRUGATE METAL PIPE
REINFORCED CONCRETE PIPE
FOLYWING CHICAIDE PIPE
GUY WIRE ANCHOR
TRANSFORMER TRANSFORMER JUNCTION BOX


POB POINT OF BEGINNING
POC POINT OF COMMENCEMENT
IPS RON PIN SET
IPF RON PIN FOUND
UP UTILITY POLE
IP LIGHT POLE
P LAG POLE
SOME SAME DANGED HANDLOLE

SANITARY SEWER MANHOLE STORM DRAIN MANHOLE

LEGEND

JUNCTION BOX
SINGLE WING CATCH BASIN
DOUBLE WING CATCH BASIN
CHAIN LINK FENCE
WATER VALVE
WATER FALVE
WATER METER
SEWER CLEAN-OUT
GAS VALVE
NOW OR FORMERLY
KET BRIDGE

ICE BRIDGE POLE

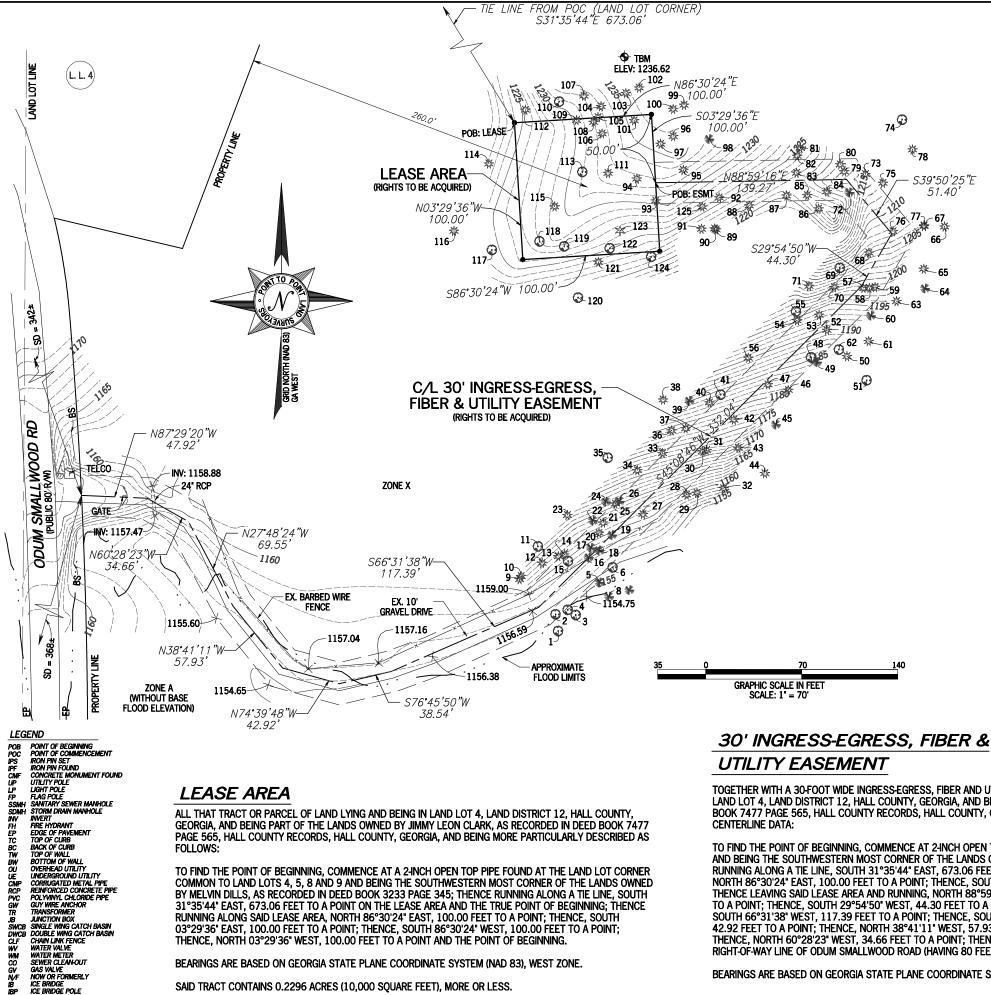

SITE INFORMATION

LEASE AREA = 10,000 SQUARE FEET (0.2296 ACRES)

LATITUDE = 34°25'48.75" (NAD 83) LONGITUDE = -83°49'52.11" (NAD 83) AT CENTER LEASE AREA

ELEVATION AT CENTER OF LEASE AREA = 1231.6' A.M.S.L.

TREE TABLE

#	DIAMETER / TREE TYPE	#	DIAMETER / TREE TYPE	#	DIAMETER / TREE TY
2	9° WATER OAK	51	26' OAK	101	13' POPLAR
	8" OAK	52	28' POPLAR		17' POPLAR
3	14" OAK TREE	53	12" POPLAR	103	16' POPLAR
4	12" OAK TREE	54	15' POPLAR	104	10' POPLAR
5	15' PINE	55	14' HARDWOOD	105	16' POPLAR
6 7	14' WATER OAK 14' PINE	56 57	18' POPLAR 15' POPLAR	106	18' POPLAR 18' POPLAR
8	13' PINE	58	12" POPLAR	108	9" POPLAR
9	8" POPLAR	59	15' POPLAR	109	13' POPLAR
_		60	9' PINE		
10	13" POPLAR			110 111	16" OAK
11	16" TRIPPLE OAK	61	13' POPLAR		20' POPLAR
12	14" POPLAR 20" POPLAR	62 63	12" OAK	112	11' POPLAR
l3 l4	20" POPLAR 9" POPLAR	64	14" POPLAR 16" PINE	113	13" OAK
				114	30' POPLAR
15	12° OAK	65	15' POPLAR	115	12' POPLAR
16	8' PINE	66	18' POPLAR	116	18' POPLAR
17	17" PINE	67	14' POPLAR	117	17" OAK
18	14' PINE	68	16' POPLAR	118	13" OAK
19	15' PINE	69	16' OAK	119	15" OAK
20	16' POPLAR	70	23' POPLAR	120	17" OAK
21	8' POPLAR	71	9° POPLAR	121	10' POPLAR
22	13' PINE	72	16' PINE	122	9" OAK
23	13' POPLAR	73	16' TWIN POPLAR	123	10' HOLLY
24	18' PINE	74	23' OAK	124	17" OAK
25	8' POPLAR	75	24' POPLAR	125	12' POPLAR
26	13' PINE	76	8' POPLAR	4	
27	42' (QUAD) POPLAR	77	14' POPLAR	4	
28	14' POPLAR	78	14' POPLAR	4	
29	17" POPLAR	79	9° POPLAR	4	
30	14' POPLAR	80	23' POPLAR	4	
31	14" POPLAR	81	14' POPLAR	4	
32	20" POPLAR	82	30' POPLAR	4	
33	12" POPLAR	83	16' POPLAR	4	
34	14" POPLAR	84	15' POPLAR	_	
35	30° OAK	85	11' POPLAR	4	
36	15' POPLAR	86	10' POPLAR	4	
37	15' POPLAR	87	16' POPLAR	4	
38	15' POPLAR	88	15' POPLAR	4	
39	10' PINE	89	9' POPLAR	_	
10	8" POPLAR	90	13' POPLAR	4	
11	17" OAK	91	15' POPLAR	_	
12	14" POPLAR	92	20' POPLAR	_	
13	14' POPLAR	93	26' POPLAR	4	
14	24" POPLAR	94	17" POPLAR	4	
15	20" PINE	95	11" POPLAR		
16	32" POPLAR	96	30' POPLAR		
17	14" POPLAR	97	11' POPLAR	4	
	17" OAK	98	18' PINE	1	
18 19	13' PINE	99	13' POPLAR	_	

UTILITY EASEMENT

TOGETHER WITH A 30-FOOT WIDE INGRESS-EGRESS. FIBER AND UTILITY EASEMENT (LYING 15 FEET EACH SIDE OF CENTERLINE) LYING AND BEING IN LAND LOT 4, LAND DISTRICT 12, HALL COUNTY, GEORGIA, AND BEING PART OF THE LANDS OWNED BY JIMMY LEON CLARK, AS RECORDED IN DEED BOOK 7477 PAGE 565, HALL COUNTY RECORDS, HALL COUNTY, GEORGIA, AND BEING MORE PARTICULARLY DESCRIBED BY THE FOLLOWING **CENTERLINE DATA:**

TO FIND THE POINT OF BEGINNING, COMMENCE AT 2-INCH OPEN TOP PIPE FOUND AT THE LAND LOT CORNER COMMON TO LAND LOTS 4, 5, 8 AND 9 AND BEING THE SOUTHWESTERN MOST CORNER OF THE LANDS OWNED BY MELVIN DILLS, AS RECORDED IN DEED BOOK 3233 PAGE 345; THENCE RUNNING ALONG A TIE LINE, SOUTH 31°35'44" EAST, 673.06 FEET TO A POINT ON THE LEASE AREA; THENCE RUNNING ALONG SAID LEASE AREA, NORTH 86°30'24" EAST, 100.00 FEET TO A POINT; THENCE, SOUTH 03°29'36" EAST, 50.00 FEET TO A POINT AND THE TRUE POINT OF BEGINNING; THENCE LEAVING SAID LEASE AREA AND RUNNING, NORTH 88°59'16" EAST, 139.27 FEET TO A POINT; THENCE, SOUTH 39°50'25" EAST, 51.40 FEET TO A POINT; THENCE, SOUTH 29°54'50" WEST, 44.30 FEET TO A POINT; THENCE, SOUTH 45°08'46" WEST, 332.04 FEET TO A POINT; THENCE, SOUTH 66°31'38" WEST, 117.39 FEET TO A POINT; THENCE, SOUTH 76°45'50" WEST, 38.54 FEET TO A POINT; THENCE, NORTH 74°39'48" WEST, 42.92 FEET TO A POINT; THENCE, NORTH 38°41'11' WEST, 57.93 FEET TO A POINT; THENCE, NORTH 27°48'24' WEST, 69.55 FEET TO A POINT; THENCE, NORTH 60°28'23' WEST, 34.66 FEET TO A POINT; THENCE, NORTH 87°29'20' WEST, 47.92 FEET TO AN ENDING POINT ON THE EASTERLY RIGHT-OF-WAY LINE OF ODUM SMALLWOOD ROAD (HAVING 80 FEET OF RIGHT-OF-WAY).

BEARINGS ARE BASED ON GEORGIA STATE PLANE COORDINATE SYSTEM (NAD 83), WEST ZONE.

GEORG! AEGISTER BO No. 2966 PLES LEE

NO.	DATE	REVISION
1	06/08/2018	ADDED TITLE - NRW
2	06/10/2019	DIMENSIONS - NRW
3	09/04/2019	TREE LOCATION
	·	

Δ

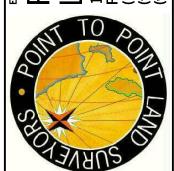


EXHIBIT SURVEY PREPARED FOR:



ALPHARETTA. GA 30022

HALLWAY

LAND LOT 4, 12TH DISTRICT HALL COUNTY, GEORGIA

DRAWN BY: RMR

CHECKED BY: JKL

APPROVED: C. INER DATE: MAY 7, 2018

SHEET:

SAID TRACT CONTAINS 0.2296 ACRES (10,000 SQUARE FEET), MORE OR LESS.

ALL THAT TRACT OR PARCEL OF LAND LYING AND BEING IN LAND LOT 4, LAND DISTRICT 12, HALL COUNTY GEORGIA, AND BEING PART OF THE LANDS OWNED BY JIMMY LEON CLARK, AS RECORDED IN DEED BOOK 7477

PAGE 565, HALL COUNTY RECORDS, HALL COUNTY, GEORGIA, AND BEING MORE PARTICULARLY DESCRIBED AS

TO FIND THE POINT OF BEGINNING. COMMENCE AT A 2-INCH OPEN TOP PIPE FOUND AT THE LAND LOT CORNER

COMMON TO LAND LOTS 4, 5, 8 AND 9 AND BEING THE SOUTHWESTERN MOST CORNER OF THE LANDS OWNED BY MELVIN DILLS, AS RECORDED IN DEED BOOK 3233 PAGE 345; THENCE RUNNING ALONG A TIE LINE, SOUTH 31°35'44" EAST, 673.06 FEET TO A POINT ON THE LEASE AREA AND THE TRUE POINT OF BEGINNING; THENCE

RUNNING ALONG SAID LEASE AREA, NORTH 86°30'24" EAST, 100.00 FEET TO A POINT; THENCE, SOUTH

03°29'36' EAST, 100.00 FEET TO A POINT; THENCE, SOUTH 86°30'24' WEST, 100.00 FEET TO A POINT;

THENCE, NORTH 03°29'36" WEST, 100.00 FEET TO A POINT AND THE POINT OF BEGINNING.

BEARINGS ARE BASED ON GEORGIA STATE PLANE COORDINATE SYSTEM (NAD 83), WEST ZONE.

LEASE AREA

FOLLOWS:

ICE BRIDGE ICE BRIDGE POLE

[SURVEY NOT VALID WITHOUT SHEET 1 OF 2] P2P JOB #: 194051GA