


D			
		07-12-2021 review	review
		07-27-2021	07-27-2021 review remarks
		01-19-2024 revised	revised
	MARK	DATE	DESCRIPTION

G2106 FILE NAME: DRAWN BY:

**EXTERIOR ELEVATIONS** 

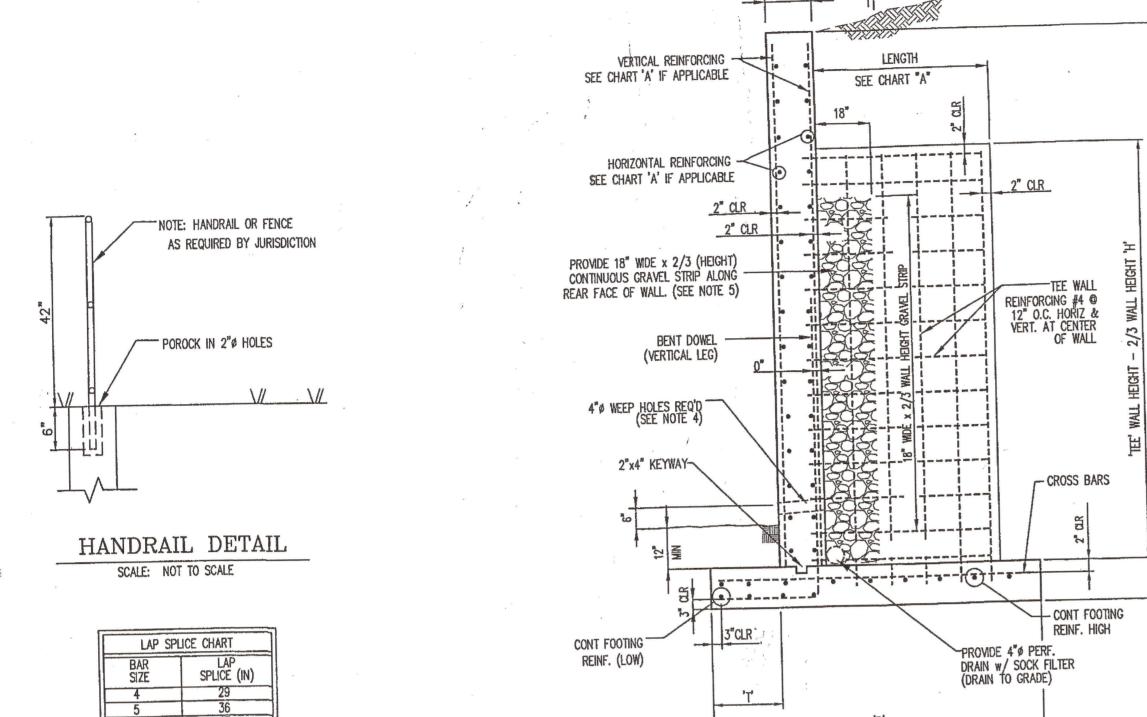

VERTICAL FACE RETAINING WALL DETAIL SCALE: NOT TO SCALE

NOTE: HANDRAIL OR FENCE AS REQUIRED BY JURISDICTION




VERTI	CAL :	RETAIL	VING I	WALL	SPECII	FICAT	MOI	S		
WALL	WALL	WALL REAR FACE			FRONT FACE			'TEE' WALL SPECIFICATIONS		
HEIGHT	MDTH	VERTICAL REINF.	HORIZ. REINF.	VERTICAL REINF.	HORIZ. REINF.	'TEE' LENGTH	'TEE' WIDTH	'TEE' SPACING		
UP TO 4'	10"	#4 @ 8"	#4 @ 18"	#4 @ 8"	#4 @ 18"	-	-	_		
OVER 4' UP TO 6'	10"	#4 @ 8"	#4 @ 18"	#4 @ 8"	#4 @ 18"	_	-	-		
OVER 6' UP TO 8'	10"	#4 @ 8"	#4 @ 18"	#4 @ 8"	#4 @ 18"	_	-			
OVER 8' UP TO 10'	10"	#4 @ 8"	#4 @ 18"	#4 @ 8"	#4 @ 18"	1'-11"	10"	12° C-C		

## CHART "A"

RETAINI	NG W	ALL	FOO	TING	SPEC	IFIC#	TIONS	3	
WALL	FTG.	TOE	FTG.	FTG. BEN		ENT DOWELS		CONTINUOUS FTG. REINFORCEMENT	
HEIGHT	WIDTH	WIDTH	DEPTH	SIZE AND	VERTICAL	HORIZ.	BAR		
'H'	'B'	T	'DF'	SPACING	LEG	LEG	REINF.	# HIGH	# LOW
UP TO 4'	2'-0"	7"	12 <sup>n</sup>	#4 @ 8"	3'-2"	1'-0"	#4 @ 16°	#5 @ 14"	#4 @ 18"
OVER 4' UP TO 6'	2'-8"	1'-0"	12"	#4 @ 8"	3'-2"	1'-5"	#4 <b>@</b> 16"	#5 @ 14"	#4 @ 18"
OVER 6' UP TO 8'	3'-8"	1'-6"	12"	#4 @ 8"	3'-2"	1'-11"	#4 @ 8"	#5 <b>9</b> 14"	#4 @ 18"
OVER 8' UP TO 10'	4'-11"	2'-0"	12"	#5 @ 8"	3,-9 <sub>n</sub>	2'-5"	#4 @ 8"	#5 @ 14"	#4 @ 18"

CHART	"B"

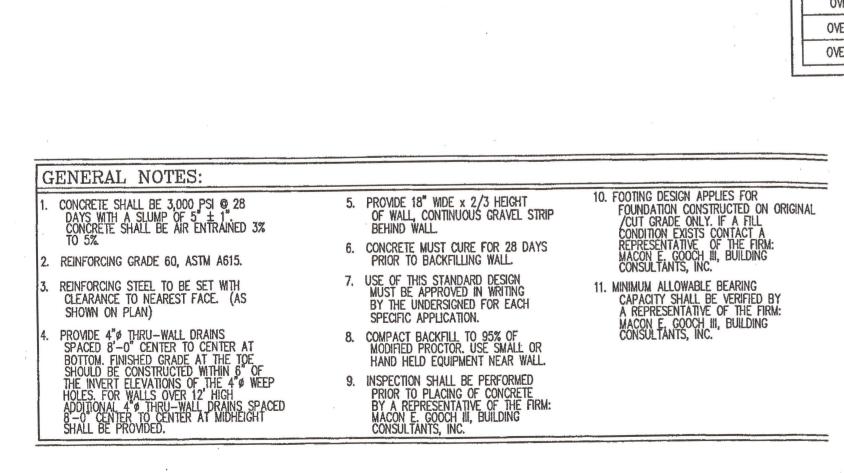

DESIGN CRITERIA:

2. REINFORCING TO BE GRADE 60 ASTM A615. 3. MINIMUM ALLOWABLE SOIL BEARING

PRESSURE TO BE 2,000 P.S.F. U.N.O.

7. THE SOIL COEFFICIENT OF FRICTION = 0.40 8. PASSIVE SOIL PRESSURE = 528 P.S.F.

5. BACKFILL MATERIAL TO BE AS SHOWN.

9. ACTIVE SOIL PRESSURE = 28.3 P.S.F.


1. CONCRETE TO BE 3,000 P.S.I. (MIN).

4. SOIL FRICTION ANGLE = 30%

6. SURCHARGE LOADING: NONE


10. SOIL DENSITY = 110 P.C.F.

11. CONCRETE DENSITY = 150 P.C.F.

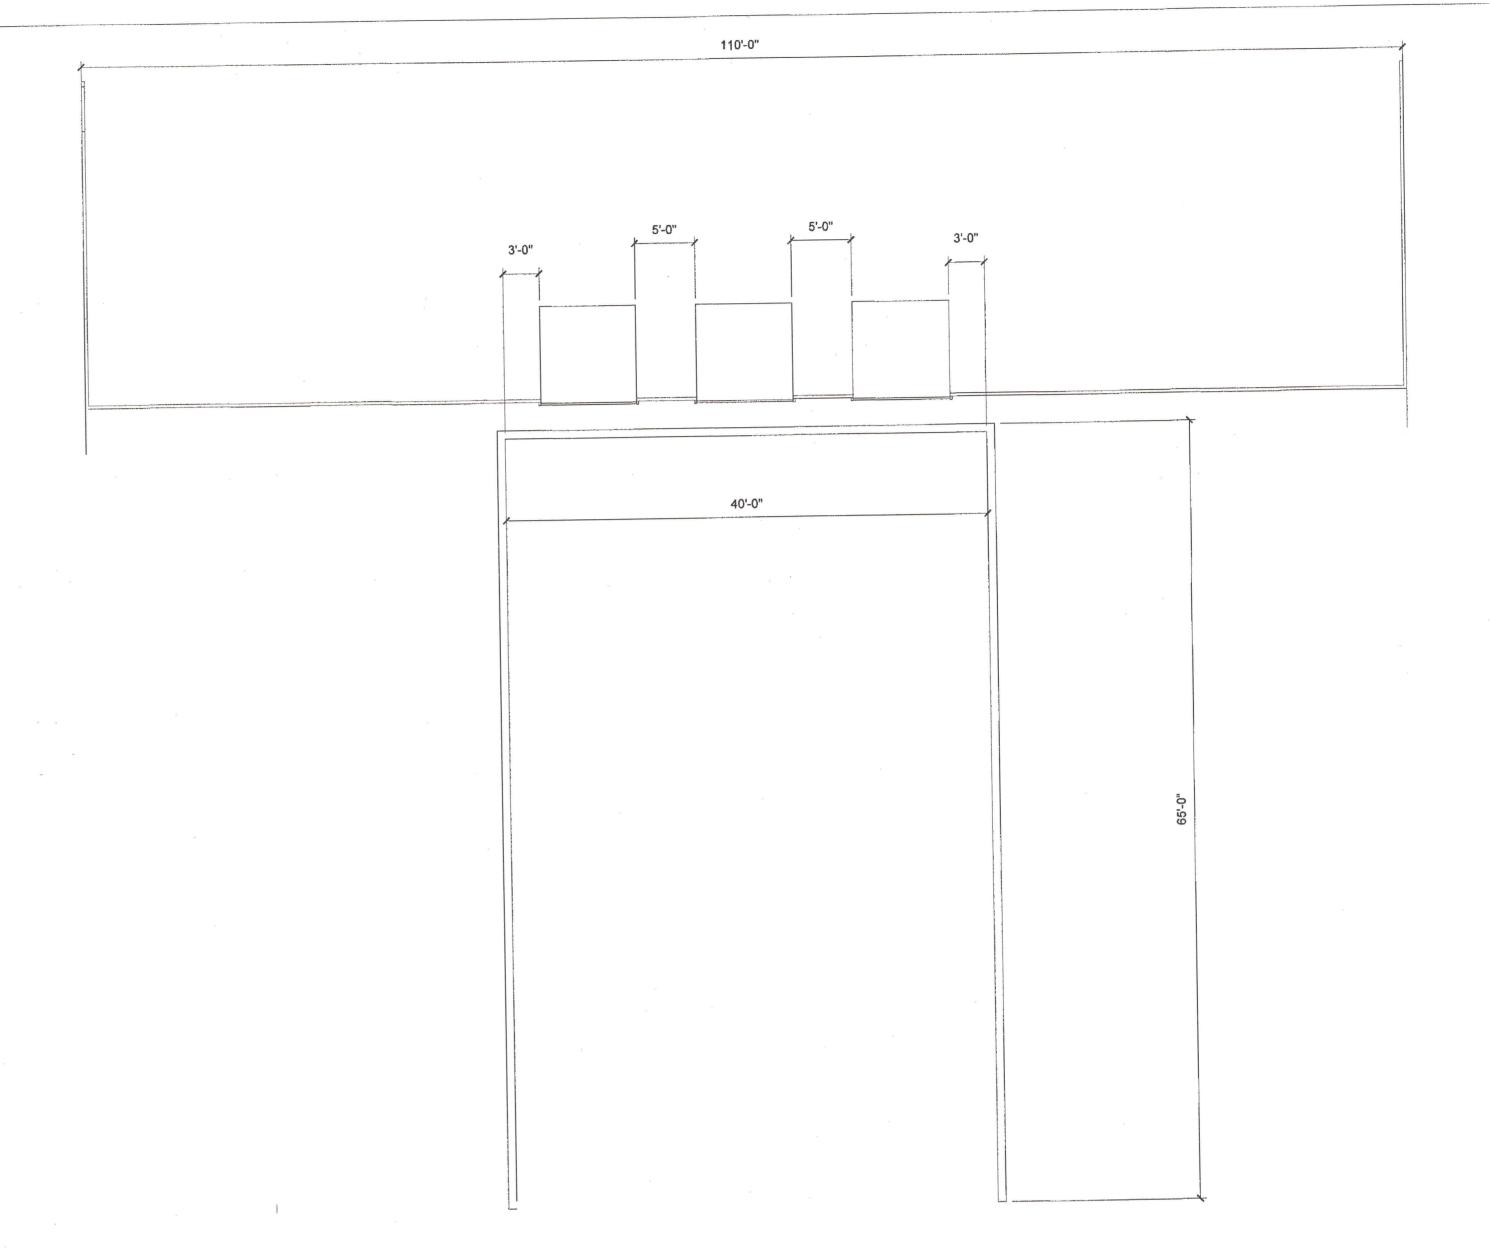


`PLAN VIEW

SCALE: 1/8" = 1'

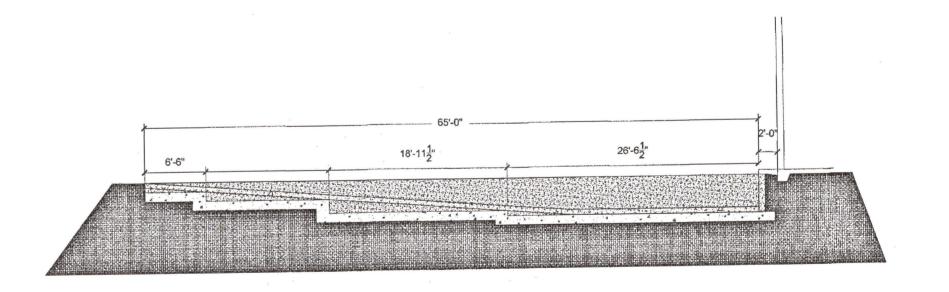

OPT. 1

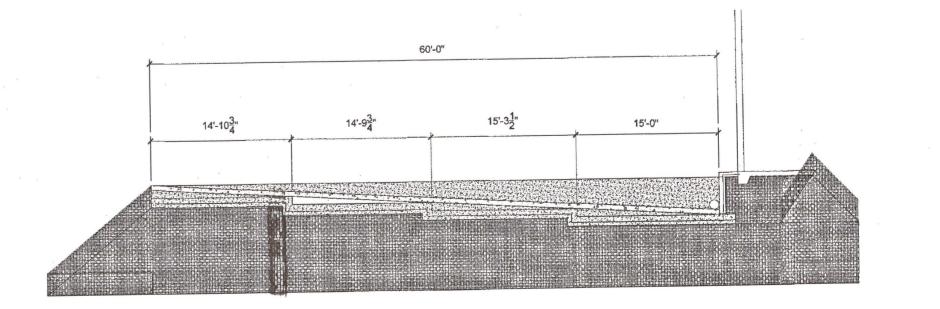

OPT. 2

NO. GCI000165 CONTRACTOR

FAX:

678.283.5898 1274 PROJECT

PROJECT OWNER

JOE BAUZA 504 ATLANTA HY GAINESVILLE, GEORGIA 470-301 5121

RELEASED FOR CONSTRUCTION: 00/ PRELIMINARY NOT FOR CONSTRUCTION: 00/C REVISION MARK DATE DESCRIPTION 5.12.21 RESPONSE TO COMM

COPYRIGHT 2021. ALL IDEAS, DESIGN DIAGRAMS, ELEVATIONS AND PLANS INDIC OR REPRESENTED

BY THIS DRAWING ARE THE PROPERTY GEORGE E. MERCURY, LLC.

AND WERE CREATED AND DEVELOPED FO SPECIFIED PROJECT AND MAY NOT BE ALTERED, CHANGED, MODIFIED, DISTRIBL OR USED FOR CONSTRUCTION UNLES PROVIDED WITH A WRITTEN AGREEMENT GEORGE E. MERCURY LLC.

WRITTEN DIMENSIONS ON THESE DRAWING SHALL HAVE PRECEDENCE OVER SCALDIMENSIONS. CONTRACTORS SHALL VERIFIED ERESPONSIBLE FOR ALL DIMENSIONS FIELD CONDITIONS ON THE JOB, AND NOT THE ARCHITECT OF ANY DISCREPANCI

SHEET

FLOOR PLAI